Robinson+Cole

GEORGE W. WATSON III

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Also admitted in Massachusetts, Connecticut and Vermont

March 29, 2024

VIA HAND DELIVERY & ELECTRONIC MAIL

Kristen Masse Coordinator RI Energy Facility Siting Board 89 Jefferson Boulevard Warwick, RI 02888

RE: Docket No. SB-2021-04 – Narragansett Electric Company Aquidneck Island Gas Reliability Project Old Mill Lane, Portsmouth, Rhode Island Updated Exhibit List and Copies of New Exhibits

Dear Kristen:

On behalf of The Narragansett Electric Company (the "Company"), I have enclosed seven copies of an updated Exhibit List along with new exhibits in the above-referenced docket. The new exhibits (TNEC-60 through TNEC-63) are maps from the Company's consultant, HDR, that reflect the revised layout. TNEC-60 is the current version of the site plan that is under review by the Rhode Island Department of Environmental Management. TNEC-61 is a noise contour map focused on the new vaporizer in the layout currently in use by the Company. TNEC-62 and TNEC-63 are noise contour maps based on the proposed layout.

Thank you for your attention to this matter. If you have any questions, please contact me at (401) 709-3351.

Sincerely,

Mary Wet

George W. Watson III

Enclosures

cc: Docket SB-2021-04 Service List

Boston | Hartford | New York | Washington, DC | Providence | Miami | Stamford | Wilmington | Philadelphia | Los Angeles | Albany | rc.com

Certificate of Service

I hereby certify that a copy of the cover letter and any materials accompanying this certificate were electronically transmitted to the individuals listed below.

The paper copies of this filing are being hand delivered to the Rhode Island Public Utilities Commission and to the Rhode Island Division of Public Utilities and Carriers.

Lad

March 29, 2024 Date

Heidi J. Seddon

SB-2021-04 The Narragansett Electric Company's Application for a License to Mobilize and Operate a Liquified Natural Gas (LNG) Vaporization Facility at Old Mill Lane (Portsmouth, RI)

Updated February 27, 2024

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Gareth Eames (Portsmouth Building Official)	geames@portsmouthri.com;

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STATE OF RHODE ISLAND ENERGY FACILITY SITING BOARD

In re: The Narragansett Electric Company : Aquidneck Island Gas Reliability Project : Portsmouth, Rhode Island :

Docket No. SB-2021-04

THE NARRAGANSETT ELECTRIC COMPANY EXHIBIT LIST

TNEC Exhibit No.	Description	Filed
TNEC-1A	Application for License to Construct and Alter Major Energy Facilities	May 19, 2021
TNEC-1B	Portable LNG Vaporization Project Siting Report	May 19, 2021
TNEC-2	Petition for Waiver Extension	May 19, 2021
TNEC-3	Slide Presentation for Preliminary Hearing	August 12, 2021
TNEC-4	October 1, 2021 Status Report to the EFSB	October 1, 2021
TNEC-5A	Prefiled Testimony of Jacques Afonso	October 1, 2021
TNEC-5B	Prefiled Joint Testimony of Danil Lamriben and Nicholas Dube	October 1, 2021
TNEC-5C	Prefiled Testimony of Tim Casey	October 1, 2021
TNEC-5C (Revision)	Prefiled Testimony of Tim Casey – Revised Page 5	November 18, 2021
TNEC-6	October 15, 2021 Status Report to the EFSB	October 15, 2021
TNEC-7	November 15, 2021 Status Report to the EFSB	November 15, 2021
TNEC-8	Portsmouth GIS Aerial Photo	November 18, 2021
TNEC-9	December 16, 2021 Status Report to the EFSB	December 16, 2021
TNEC-10	January 14, 2022 Status Report to the EFSB	January 14, 2022

TNEC-11	February 15, 2022 Status Report to the EFSB	February 15, 2022
TNEC-12	March 15, 2022 Status Report to the EFSB	March 15, 2022
TNEC-13	AIGRP License Application (Supplemental Application)	April 1, 2022
TNEC-14	AIGRP Siting Report	April 1, 2022
TNEC-14A	AIGRP Siting Report – Replacement Pages (Pages 115-116c)	April 28, 2022
TNEC-14B	AIGRP Siting – Replacement Pages (Page 43, Appendix G)	August 4, 2022
TNEC-15	Petition for Second Waiver Extension	July 11, 2022
TNEC-16	AIGRP Preliminary Hearing – PowerPoint Presentation	July 25, 2022
TNEC-17	Prefiled Testimony of Jeffrey Montigny	September 8, 2023
TNEC-18	Prefiled Testimony of Brian Kirkwood	September 8, 2023
TNEC-19	Prefiled Testimony of Julie Porcaro	September 8, 2023
TNEC-20	Prefiled Testimony of Jacques Afonso	September 8, 2023
TNEC-21	Prefiled Testimony of Timothy Casey	September 8, 2023
TNEC-22	Prefiled Rebuttal Testimony of Jeffrey A. Montigny	November 3, 2023
TNEC-23	Prefiled Rebuttal Testimony of Stuart A. Wilson	November 3, 2023
TNEC-24	Prefiled Rebuttal Testimony of Brett s. Feldman	November 3, 2023
TNEC-25	Prefiled Direct Testimony of Tyler Olney	November 3, 2023
TNEC-26	Prefiled Rebuttal Testimony of Pat Convery	November 3, 2023
TNEC-27	Responses to Acadia's Data Requests from 11-18-2021 Hearing	January 14, 2022

TNEC-28	Responses to EFSB's Record Requests from 11-18-2021 Hearing	January 14, 2022
TNEC-29	Responses to EFSB's First Set of Data Requests	May 13, 2022
TNEC-30	Supplemental Response to EFSB's Data Request 1-4 – CONFIDENTIAL	June 9, 2022
TNEC-31	Petition for Second Waiver Extension	July 11, 2022
TNEC-32	Responses to EFSB's Record Requests from 07-25-2022 Hearing - CONFIDENTIAL	August 17, 2022
TNEC-33	TNEC's Notice re Temporary Mobilization	September 27, 2022
TNEC-34	Responses to EFSB Set 2 (has confidential component – conf attachments filed separately – no part of a confidential set – <i>please advise</i>)	January 6, 2023
TNEC-35	Motion to Extend Deadline to Submit Advisory Opinion	January 6, 2023
TNEC-36	Responses to Portsmouth Set 1 (Attachments 1-15-2, 1-15-3, 1- 15-4 filed in excel format)	March 1, 2023
TNEC-37	Responses to EFSB Set 3	March 14, 2023
TNEC-38	Motion to Extend Deadline to Submit Advisory opinion	May 12, 2023
TNEC-39	Supplement to Motion to Extend Deadline to Submit Advisory Opinion	May 17, 2023
TNEC-40	Notice of Mobilization	September 7, 2023
TNEC-40	Petition for Third Waiver Extension	September 7, 2023
TNEC-41	Notice of Off-Hour Delivery Events	October 3, 3023
TNEC-42	PUC Docket No. 22-42-NG – Company Response to CLF 1-5	February 27, 2024
TNEC-43	PUC Docket No. 22-42-NG – Company Response to Division 1-1	February 27, 2024

TNEC-44	PUC Docket No. 22-42-NG – Company Response to Division 1-2	February 27, 2024
TNEC-45	PUC Docket No. 22-42-NG – Company Response to Division 2-1	February 27, 2024
TNEC-46	PUC Docket No. 22-42-NG – Company Response to Division 4-1	February 27, 2024
TNEC-47	PUC Docket No. 22-42-NG – Company Response to Division 4-3	February 27, 2024
TNEC-48	PUC Docket No. 22-42-NG – Company Response to Division 4-4	February 27, 2024
TNEC-49	PUC Docket No. 22-42-NG – Company Response to PUC 1-9	February 27, 2024
TNEC-50	PUC Docket No. 22-42-NG – Company Response to PUC 1-11	February 27, 2024
TNEC-51	PUC Docket No. 22-42-NG – Company Response to PUC 1-13	February 27, 2024
TNEC-52	PUC Docket No. 22-42-NG – Company Response to PUC 2-1	February 27, 2024
TNEC-53	PUC Docket No. 22-42-NG – Company Response to PUC 3-1	February 27, 2024
TNEC-54	PUC Docket No. 22-42-NG – Company Response to PUC 3-2	February 27, 2024
TNEC-55	PUC Docket No. 22-42-NG – Company Response to PUC 3-3	February 27, 2024
TNEC-56	PUC Docket No. 22-42-NG – Company Response to Middletown 1-4	February 27, 2024
TNEC-57	PUC Docket No. 22-42-NG – Company Response to Middletown 1-5	February 27, 2024
TNEC-58	PUC Docket No. 22-42-NG – Company Response to Middletown 2-4	February 27, 2024
TNEC-59	PUC Docket No. 22-42-NG – Company Response to Middletown 3-1	February 27, 2024
TNEC-60	HDR – Civil Plan Set Dated 01-12-2024	March 29, 2024

TNEC-61	HDR – Operational Noise Contours, Existing Case – Date 7/26/2023	March 29, 2024
TNEC-62	HDR – 500 MSCFH Vaporizer and Pump Trailer Operation- Noise Contour Map – Date 03/28/2023	March 29, 2024
TNEC-63	HDR – Storage Tank Cooldown - Noise Contour Map – Date 06/21/2023	March 29, 2024

Date: March 29, 2024







2



SUE	DATE	DESCRIPTION
1	02/18/2022	CIVIL PLAN SET
2	05/05/2022	REVISED CIVIL PLAN SET
3	05/27/2022	REVISED CIVIL PLAN SET
4	09/29/2023	REVISED CIVIL PLAN SET FOR NEW LAYOUT
5	11/29/2023	REVISED CIVIL PLAN SET PER RIDEM COMMENTS
6	01/12/2024	REVISED CIVIL PLAN SET PER RIDEM COMMENTS

THE NARRAGANSETT ELECTRIC COMPANY **AQUIDNECK ISLAND GAS RELIABILITY PROJECT** OLD MILL LANE, PORTSMOUTH, RI

CIVIL PLAN SET

LOCATION MAP SCALE: 1" = 500'

OLD MILL LANE PORTSMOUTH, RHODE ISLAND

> **TOWN OF PORTSMOUTH** MAP 68 LOT 74

RHODE ISLAND ENERGY
AQUIDNECK ISLAND GAS RELIABILITY
OLD MILL LANE, PORTSMOUTH,


TOWNSHIP OF PORTSMOUTH MAP 68, LOT 74

PROJECT MANAGER	ANKIT DHAR
DESIGNED BY	B. PAULA
DRAWN BY	W. LIN
CHECKED BY	H. NEENAN
APPROVED BY	A. DHAR
PROJECT NUMBER	10328992

Y PROJECT H, RI	COVER SH	IEET
	0 1" 2" FILENAME SCALE -	SHEET 1 OF 8 G-1

DRAWING INDEX

OF 8	G-1	COVER SHEET
2 OF 8	G-2	EXISTING CONDITIONS PLAN
3 OF 8	C-1	PROPOSED SITE LAYOUT PLAN
4 OF 8	C-2	CIVIL DETAILS
5 OF 8	C-3	EROSION & SEDIMENT CONTROL PLAN
6 OF 8	C-4	EROSION & SEDIMENT CONTROL DETAILS
7 OF 8		OLD MILL LANE WETLAND MITIGATION/ENHANCEMENT PLAN
3 OF 8		EXISTING CONDITIONS SURVEY SHOWING LOT 74 BOUNDARY

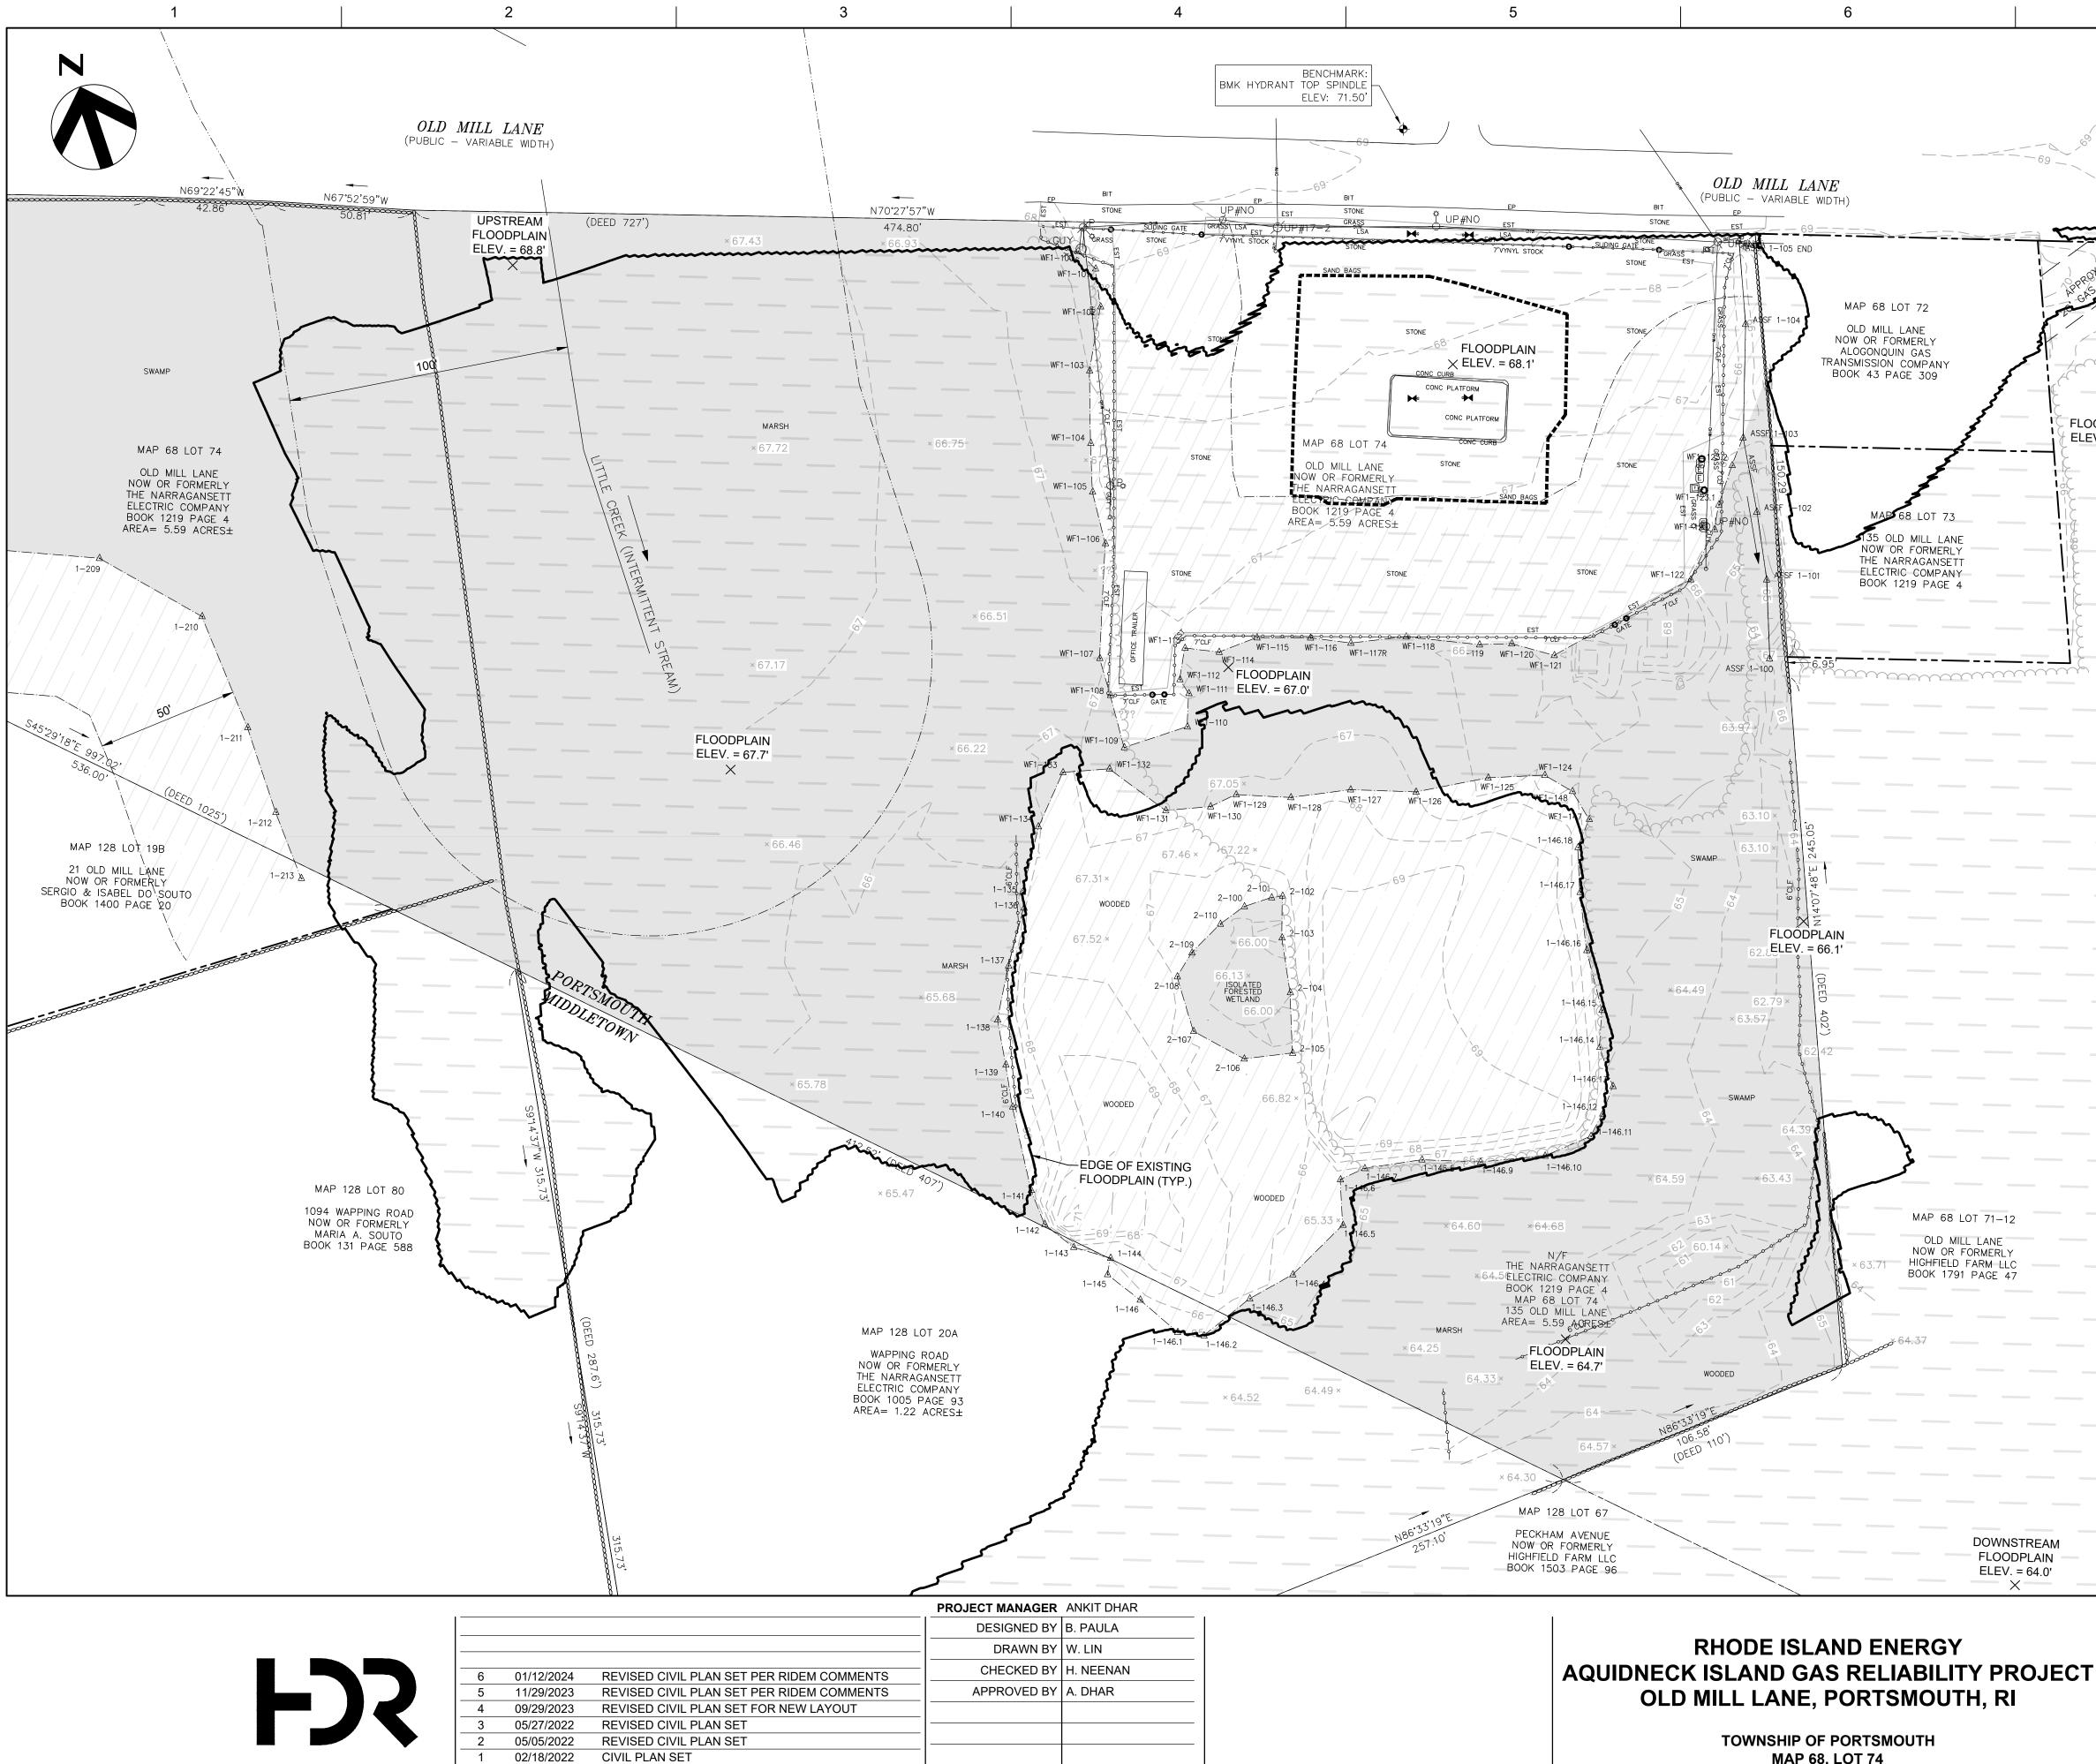

DATE

ISSUE

DESCRIPTION

PROJECT NUMBER 10328992

MAP 68, LOT 74

FLOODPLAIN ELEV. = 67.3'	RATE MAP 440 LOCATED WIT FLOOD HAZAF DISPLACEMEN PROPOSED D DISPLACEMEN SEPARATE CO 5. EXISTING FLC	TO FEMA FLOOD INSURANCE D05C0113J, THE PROJECT SITE IS THIN ZONE X (AREA OF MINIMAL RD). NO FLOODPLAIN NT ANTICIPATED FROM EVELOPMENT (SEE FLOODPLAIN NT ANALYSIS, PROVIDED UNDER DVER). DODPLAIN ELEVATIONS ARE TO THE NEAREST 0.1-FT.
	LEGEND	
		EXISTING CONDITION FLOODPLAIN
	FLOODPLAIN \times ELEV. = 66.0'	EXISTING CONDITION FLOODPLAIN SPOT ELEVATION
		EXISTING WETLANDS
		PERIMETER WETLANDS
	<u>入</u> WF1-128	WETLAND FLAG
		PROPERTY LINE
		EASEMENT
		STONE WALL
	-0000000000000-	CHAIN LINK FENCE
	-0000000000000-	VINYL STOCKADE FENCE
		SAND BAGS
	— 60— —	CONTOUR
	E	ELECTRIC METER
71–12		TELEPHONE BOX
ANE IERLY M LLC	H	GAS VALVE
GE 47	GUY o	GUY WIRE ANCHOR
	GUY ()	GUY POLE
	UP Ø	UTILITY POLE
	UP D	UTILITY POLE WITH TRANSFORMER
	UP ≎-Φ	UTILITY POLE WITH LIGHT
	ι ι ι	LIGHT POLE
	ВМК	BENCHMARK
	EP	EDGE OF PAVEMENT
	EST	EDGE CRUSHED STONE
DWNSTREAM	LSA	LANDSCAPED AREA

NOTES:

1. WETLAND LOCATIONS BASED ON FLAGGED

2. EXISTING CONDITIONS BASED ON SURVEY

ENTITLED "EXISTING CONDITIONS SURVEY",

PREPARED BY WSP, DATED FEBRUARY 2,

2023, AND SURVEY ENTITLED "EXISTING

3. LOCATION OF LITTLE CREEK HAS BEEN

APPROXIMATED VIA AERIAL IMAGERY.

CONDITIONS SURVEY", PREPARED BY WSP,

D

DATA PROVIDED TO HDR BY THE NARRAGANSETT ELECTRIC COMPANY.

DATED DECEMBER 8, 2021.

-67

FLOODPLAIN = ELEV. = 64.0' $\times -$


EXISTING CONDITIONS PLAN

FILENAME

SCALE | 1" = 30'

SHEET 2 OF 8

G-2

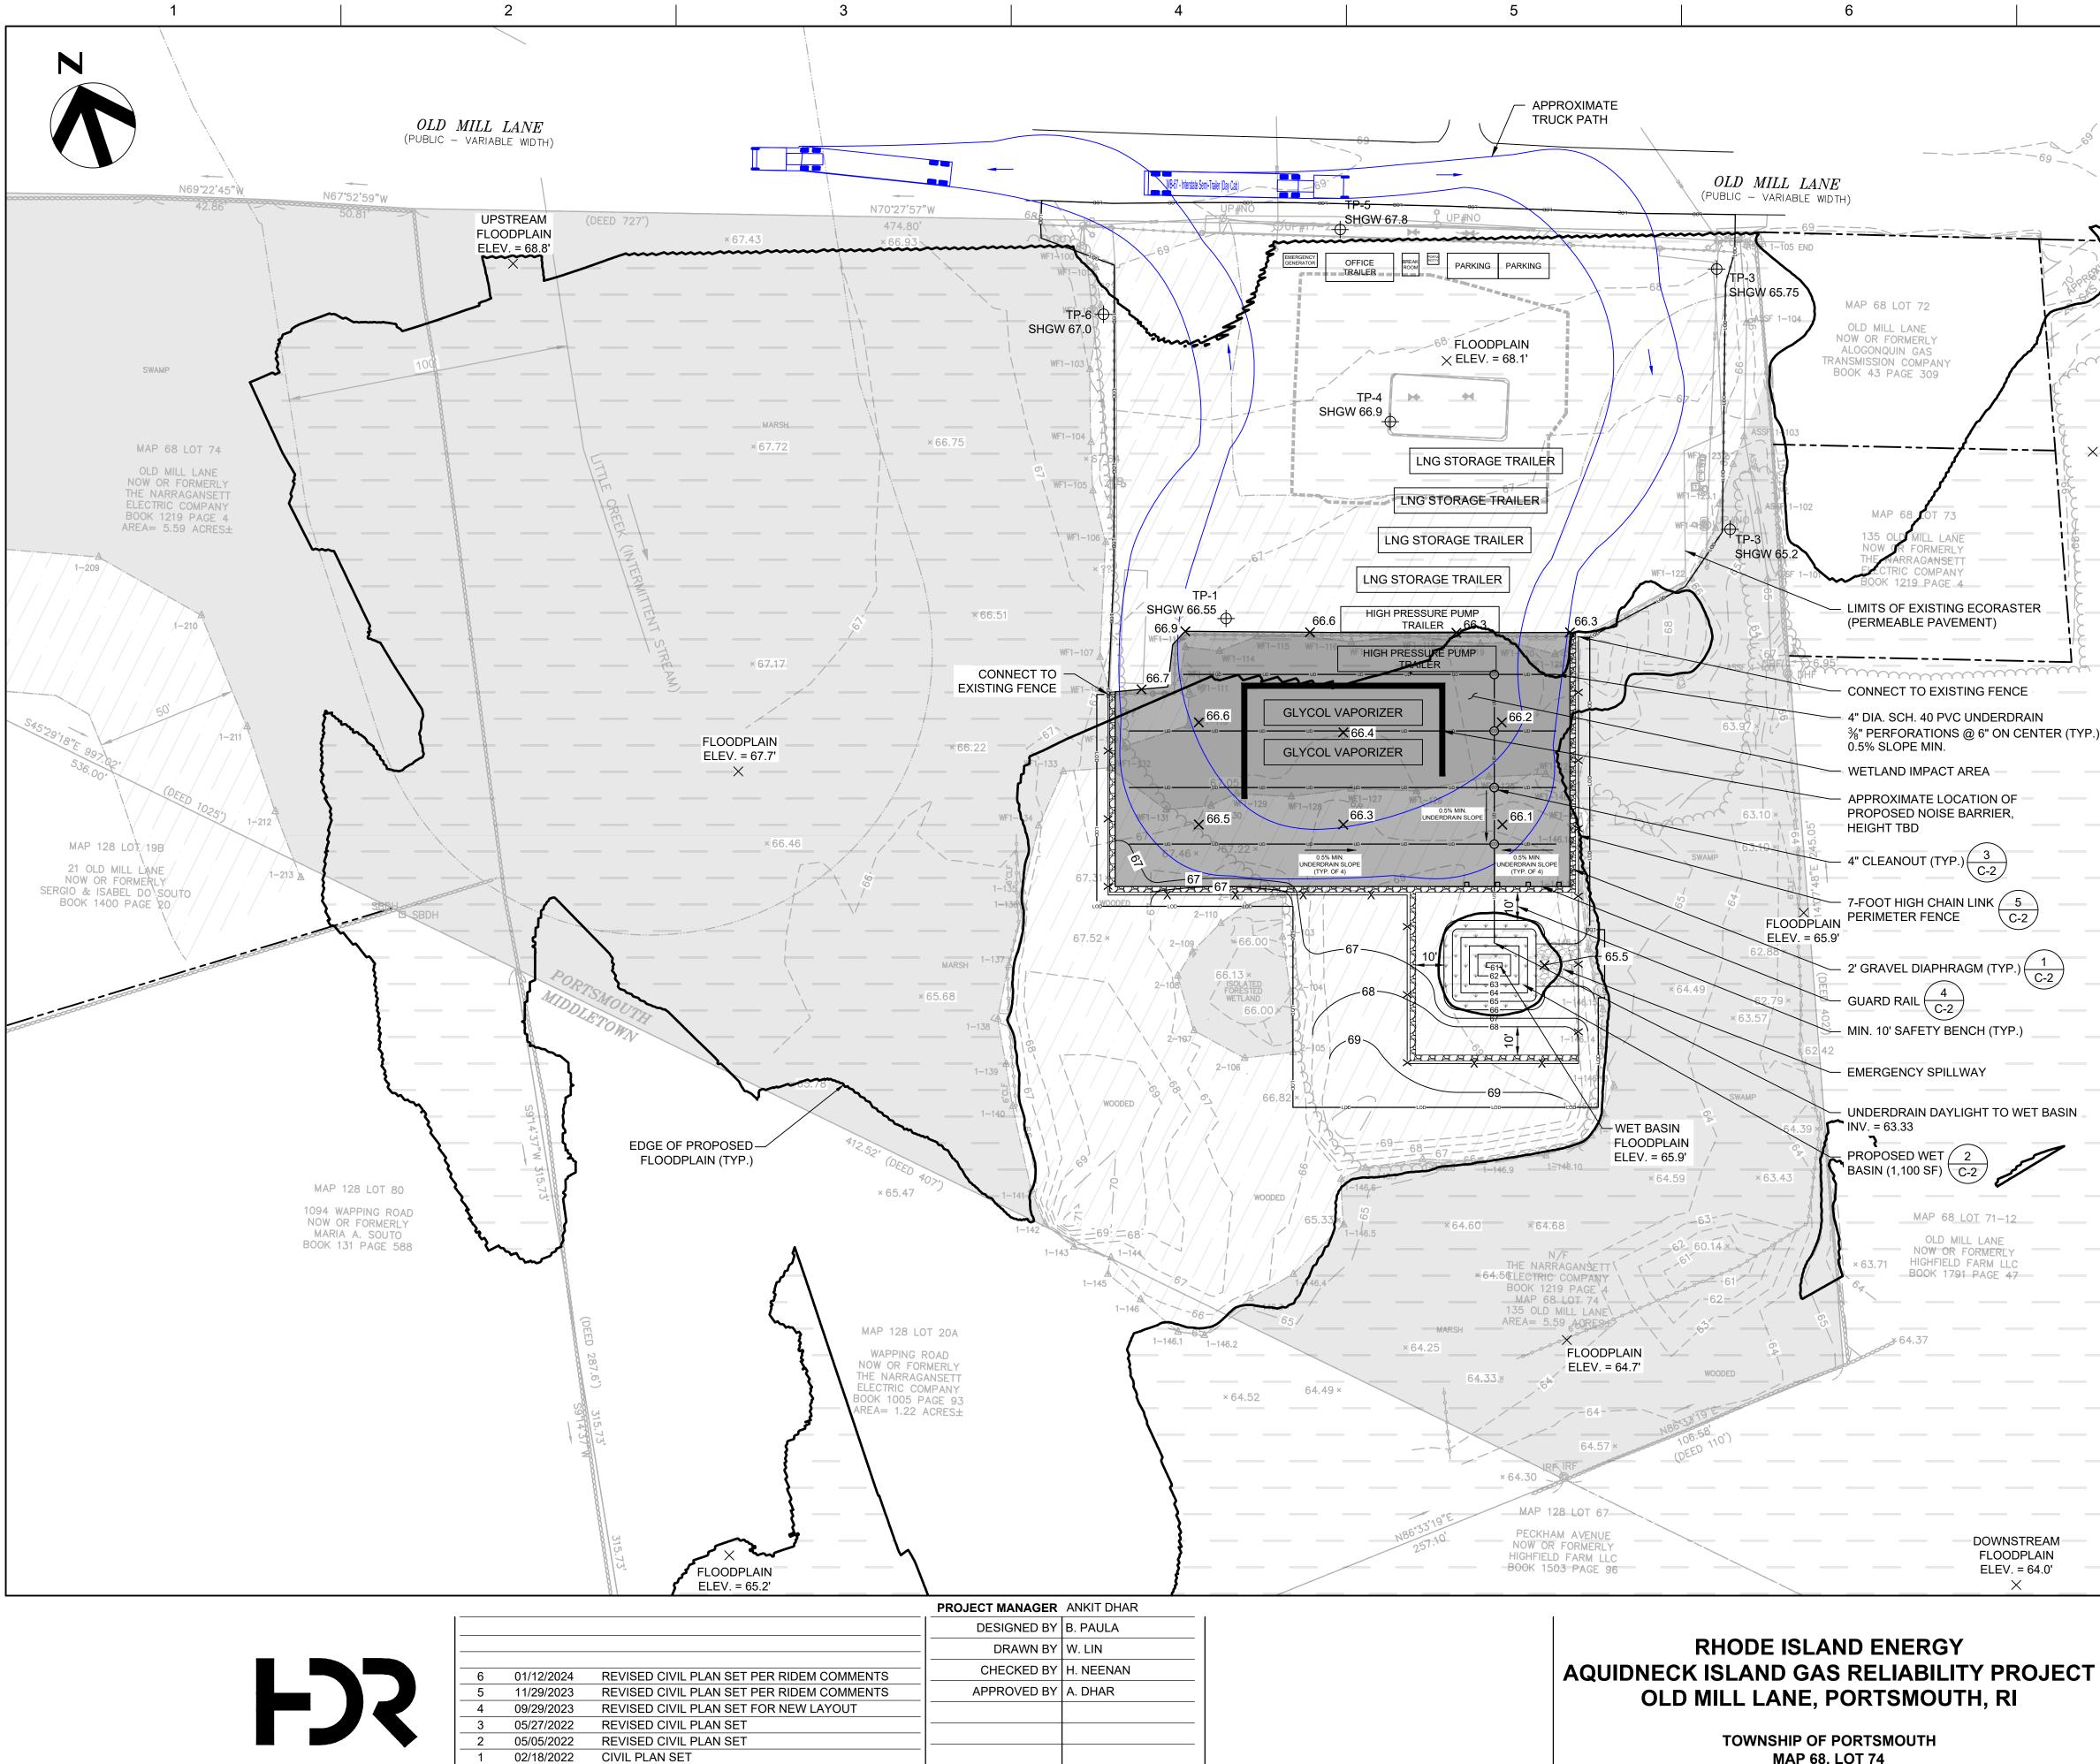

ISSUE

DATE

CIVIL PLAN SET

DESCRIPTION


PROJECT NUMBER 10328992


MAP 68, LOT 74

	7	8	
		NOTES:]
		 SOIL TEST LOCATIONS ARE APPROXIMATE AND BASED ON SOIL TESTING PERFORMED ON SITE BY VHB ON NOVEMBER 8, 2021. REFER TO STORMWATER MANAGEMENT REPORT FOR SOIL TESTING DATA AND GROUNDWATER INFORMATION. 	
	-69	2. GAS AND ELECTRICAL UTILITIES TO BE INSTALLED UNDERGROUND WITHIN THE LIMIT OF DISTURBANCE.	
	T	 ALL WORK SHALL BE PERFORMED WITHIN LIMIT OF DISTURBANCE TO MINIMIZE IMPACTS TO EXISTING WETLANDS. 	D
/		4. PROPOSED FLOODPLAIN ELEVATIONS ARE ROUNDED UP TO THE NEAREST 0.1-FT.	
		}	
	-		
ORASTI T)			С
FENCE			
	AIN		
		LEGEND	
N OF -		PERMEABLE PAVEMENT	
RIER,			
3		$\begin{array}{c} & & & \\ & & & & \\ & & & \\ & & & & & \\ & & & & & \\ & & & & \\ & & & & & \\ & & & & & \\ & & & & & \\ & & &$	
к _ 5		GRAVEL	
C-2		GUARD RAIL	
(TYP.) (66 PROPOSED CONTOUR	
		X PROPOSED FENCE	В
(TYP.)		× ^{67.5} PROPOSED SPOT GROUND ELEVATION	
TO WE	ET BASIN	APPROXIMATE SOIL TP-1 TEST LOCATION SHGW 66.55	
		EXISTING TREE LINE	
ß		EXISTING WETLANDS	
71– <u>12</u>		PERIMETER WETLANDS	
ANE IERLY M LLC GE 47		PROPOSED CONDITION FLOODPLAIN	
		FLOODPLAINPROPOSED CONDITIONX ELEV. = 66.0'FLOODPLAIN SPOT ELEVATION	
		LIMIT OF DISTURBANCE	
			A
		☺ CLEANOUT	
		APPROXIMATE WETLAND	
		DISTURBANCE AREA: 8,485 SF (0.19 ACRES)	
	LAIN	DISTURBANCE AREA: 32,710 SF (0.75 ACRES)	
LEV. =	04.U		

PROPOSED SITE LAYOUT PLAN

FILENAME SCALE 1" = 30' SHEET 3 OF 8 C-1

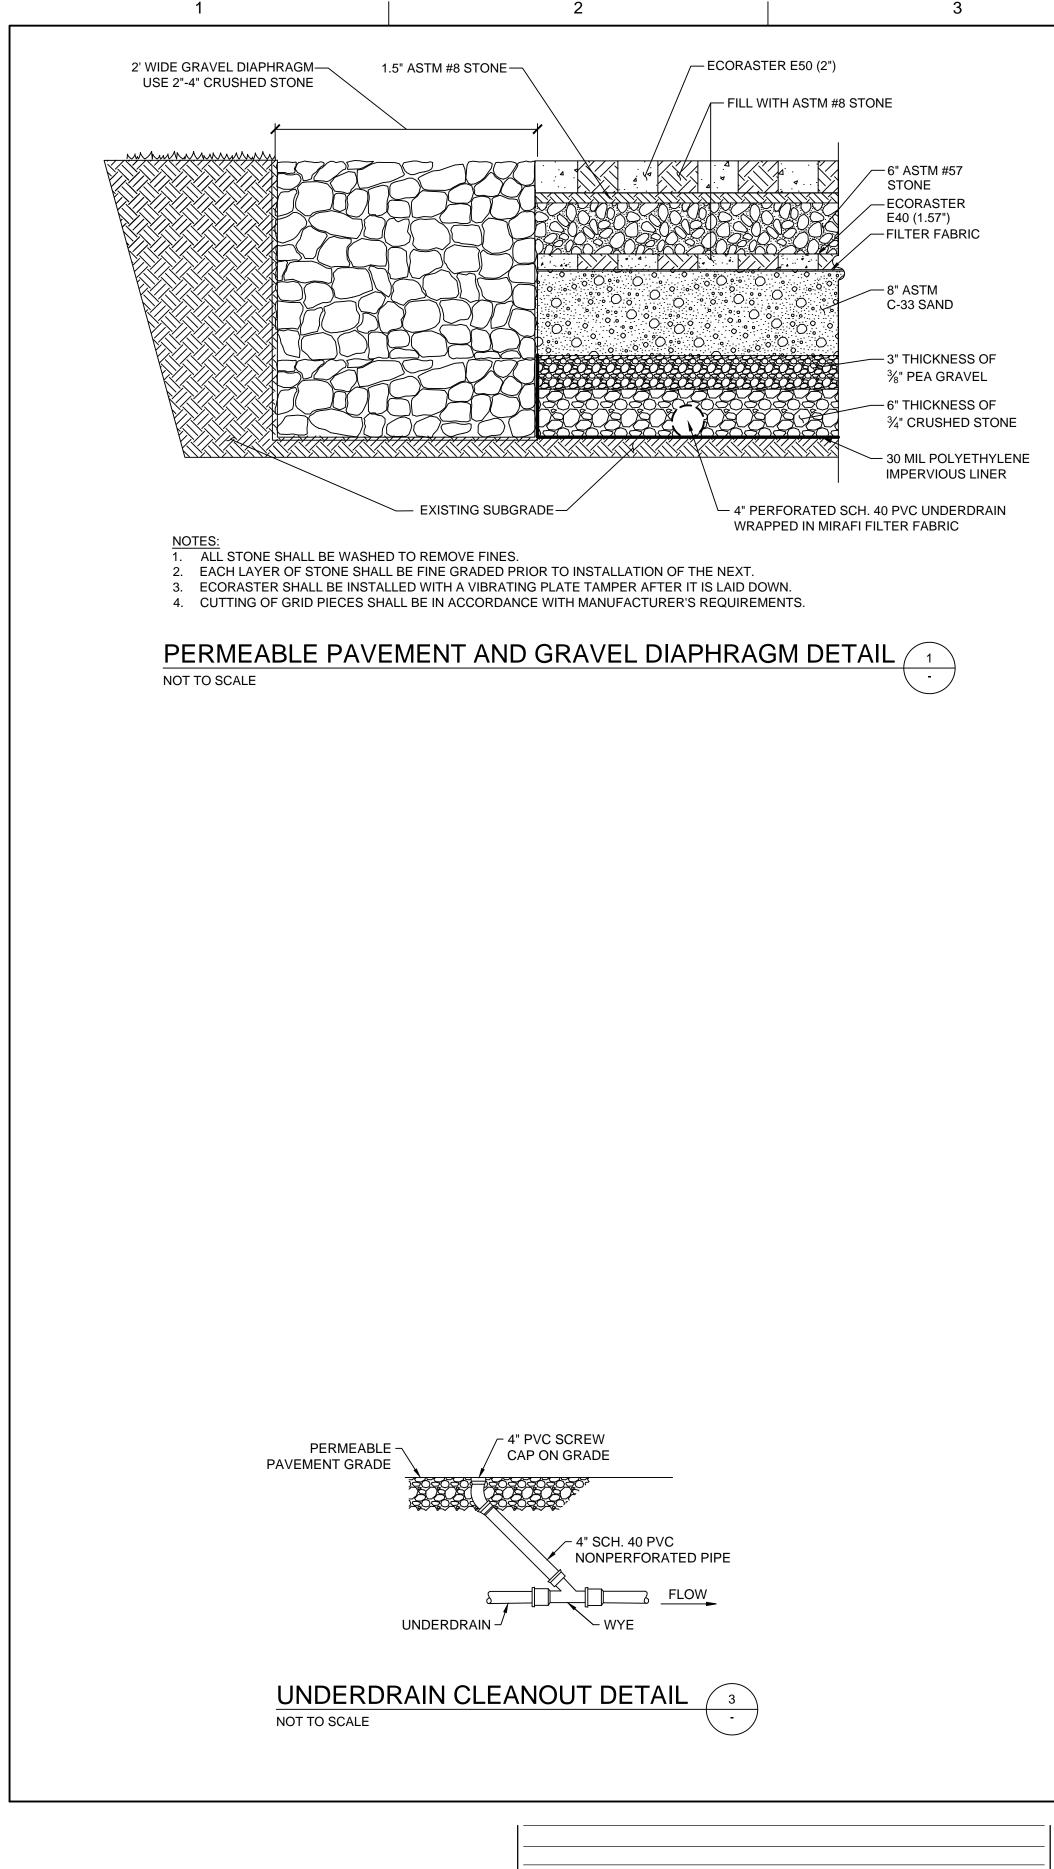

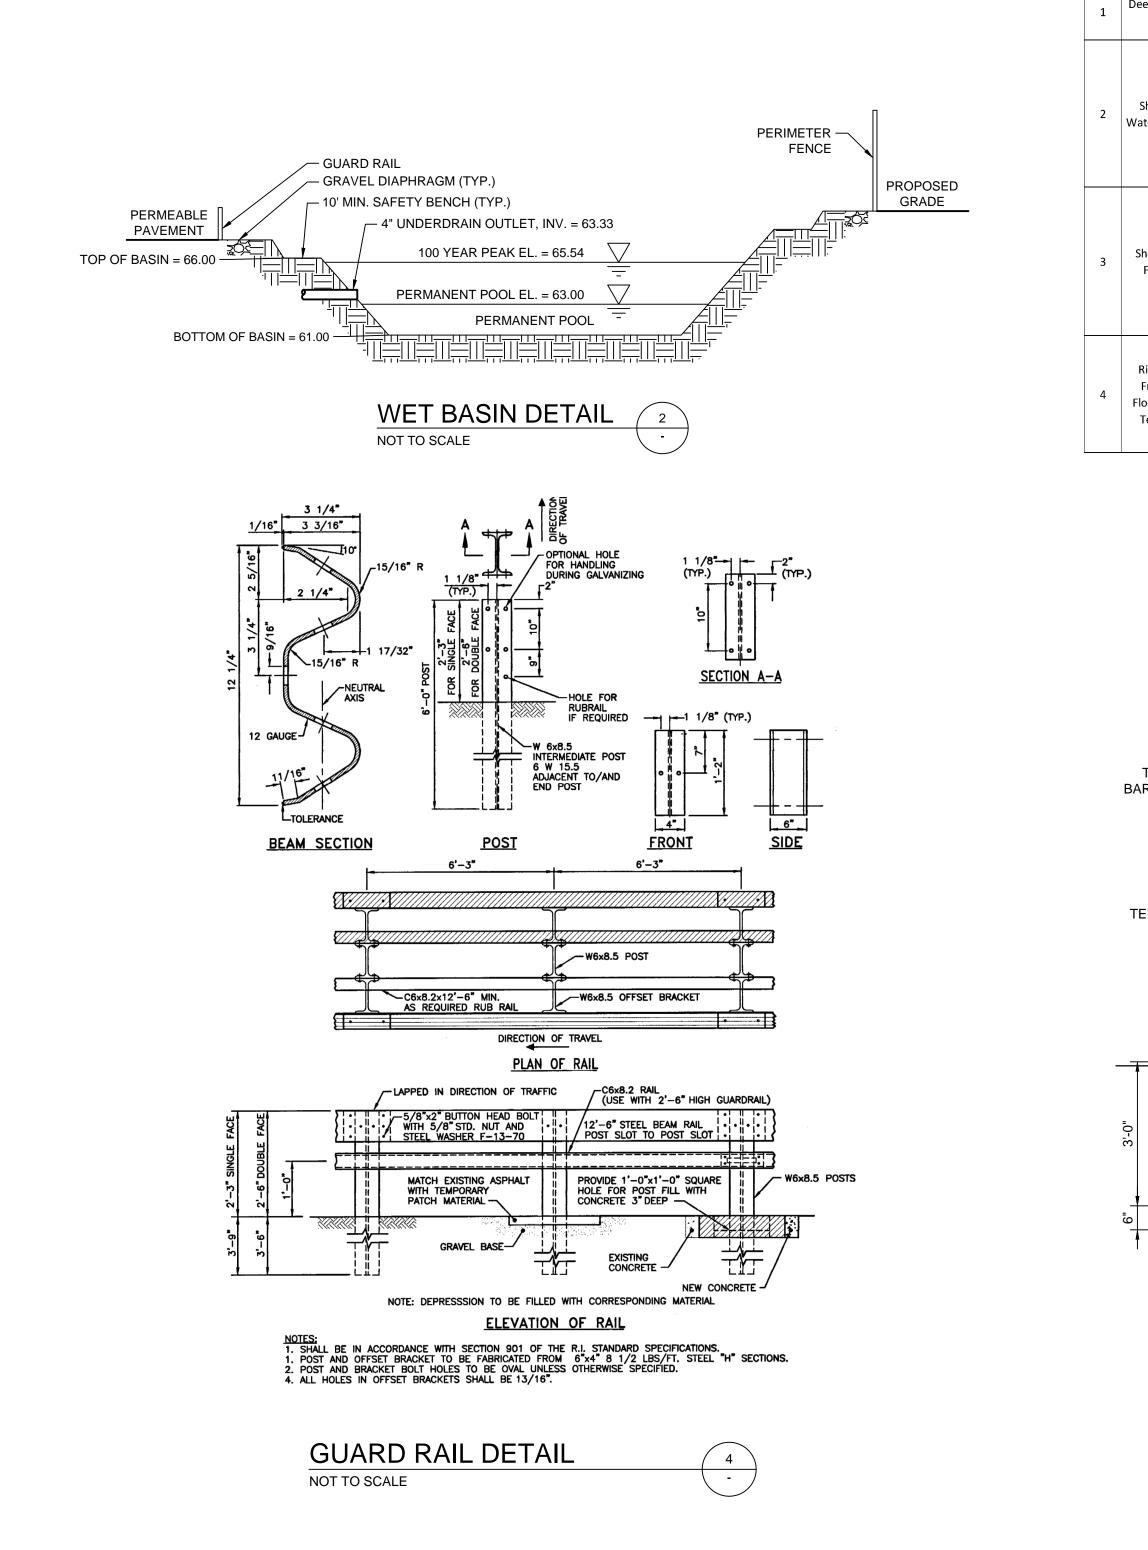

RHODE ISLAND ENERGY
AQUIDNECK ISLAND GAS RELIABILITY P
OLD MILL LANE, PORTSMOUTH, I

TOWNSHIP OF PORTSMOUTH MAP 68, LOT 74

PROJECT MANAGER	ANKIT DHAR
DESIGNED BY	B. PAULA
DRAWN BY	W. LIN
CHECKED BY	H. NEENAN
APPROVED BY	A. DHAR
PROJECT NUMBER	10328992

REVISED CIVIL PLAN SET PER RIDEM COMMENTS

REVISED CIVIL PLAN SET PER RIDEM COMMENTS

REVISED CIVIL PLAN SET FOR NEW LAYOUT

REVISED CIVIL PLAN SET

REVISED CIVIL PLAN SET

CIVIL PLAN SET

DESCRIPTION

01/12/2024

11/29/2023

09/29/2023 05/27/2022

05/05/2022

02/18/2022

DATE

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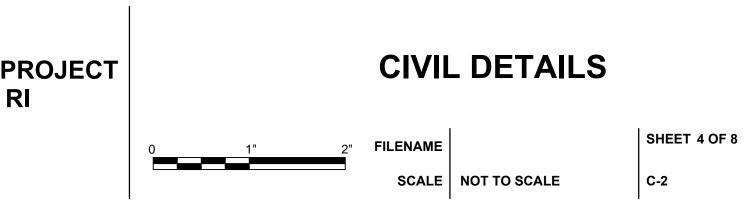
ISSUE

WET BASIN PLANT LIST							
Zone	Description	Elevation Range	Common Name	Scientific Name	Plant or plug Density per sq. yd.	Seeding Type	Application Rate
1	Deep Water	Water 61-63	Waterweed	Elodea canadensis Vallisneria	1	None	N/A
-	Pool	01 05	Mild Colom	Americana		None	
			Wild Celery Arrow arum	Peltandra virginica	3		
			Arrowhead	Sagittaria latifolia	3	-	
			Arrowneau	Sparganium	5	-	
			Giant Burreed	. –	3		
2	Shallow	62.66	Pickerelweed	eurycarpum Pontederia cordata	1	-	
2	Water Bench	63-66				None	N/A
			Rice Cutgrass Soft Rush	Leersia oryzoides Juncus effusus	1 6	-	
			Wool Grass		1		
				Scirpus cyperinus	_		
			Spatterdock	Nuphar luteum	0.25		
			Arrow arum Arrowhead	Peltandra virginica		-	
			Arrownead	Sagittaria latifolia Hibiscus	1	-	
			N 4		1		
-	Shoreline Fringe	66-68	Marsh Hibiscus	moscheutos	1	New England WetMix *	1 Lb/2500 sq ft
3			Rice Cutgrass	Leersia oryzoides	1		
			Soft Rush	Juncus effusus	3	-	
				Cephalanthus			
			Buttonbush	occidentalis	0.5	-	
			Swamp Rose	Rosa palustris	0.25		
			Switchgrass	Panicum virgatum	1	-	
4	Riparian Fringe/	69 +		Sambucus nigra -		New England Erosion Control/Restora tion Mix*	1 Lb/1250 sq
			Elderberry	canadensis	0.25		
	Floodplain		Silky Dogwood	Cornus amomium	0.25		ft
	Terrace		Swamp Rose	Rosa palustris	0.5		
	Terrace	race	Winterberry	Ilex verticillata	0.5		
				Sweetpepperbush	Clethra alnifolia	0.25	

10'-0" MAXIMUM -1¼" OD TOP RAIL CHAIN LINK FABRIC TENSION -#9 GAUGE 2" MESH -BAR BANDS 1 ¼" OD — BRACE TUBE 후 단 **TENSION** 3/8" TRUSS ROD BAR - END, CORNER OR PULL POST (STEEL) 4" OD STEEL PIPE - CORNER LINE POST -AND PULL POSTS TO 2 ½" OD HAVE EQUAL BRACING STEEL PIPE ON BOTH SIDES 12" 10"

1. PULL POST SHALL BE USED AT SHARP BREAKS IN VERTICAL GRADES OR AT APPROXIMATELY 330' CENTERS ON STRAIGHT RUNS, OR AS DIRECTED BY THE ENGINEER. 2. SPLICES SHALL BE IN WOVEN WIRE FABRIC ONLY AT CORNER, GATE END, OR PULL POSTS.






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DATE	DESCRIPTION
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REVISED CIVIL PLAN SET

REVISED CIVIL PLAN SET PER RIDEM COMMENTS

REVISED CIVIL PLAN SET PER RIDEM COMMENTS

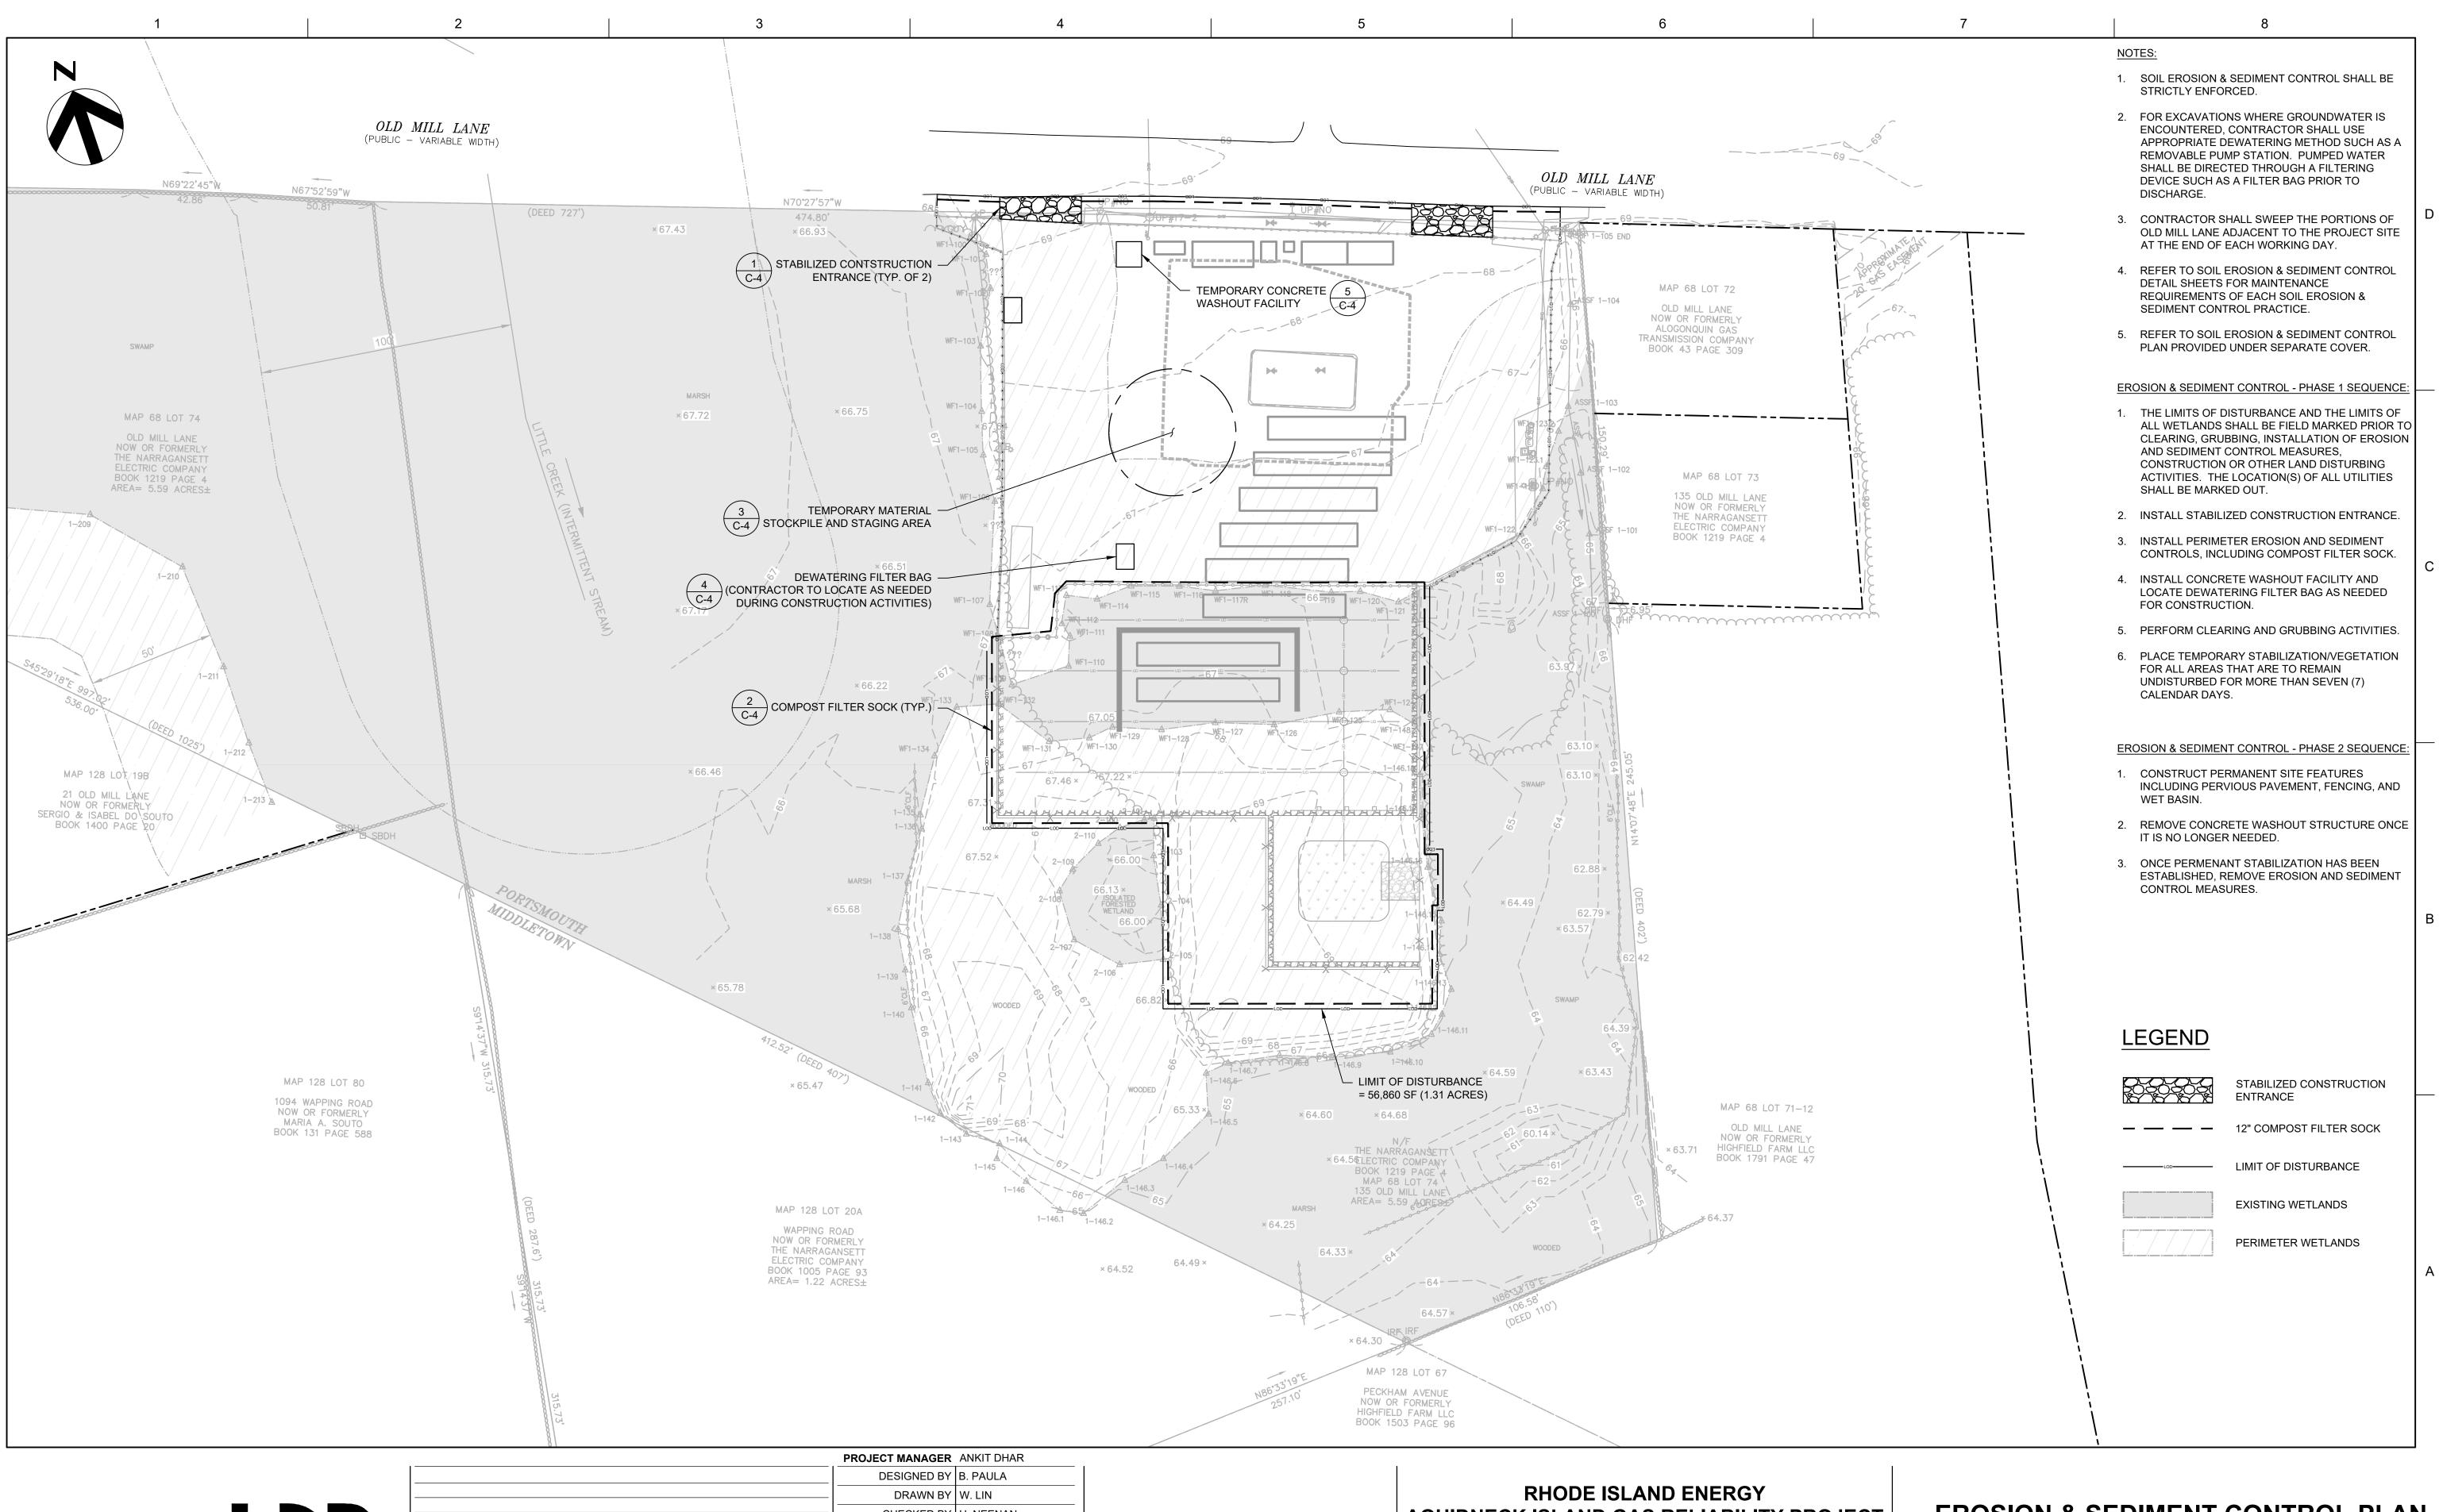REVISED CIVIL PLAN SET FOR NEW LAYOUT

DESCRIPTION

01/12/2024

11/29/2023

09/29/2023

05/27/2022

4

1

ISSUE


AQUIDNECK ISLAND GAS RELIABILITY PROJECT OLD MILL LANE, PORTSMOUTH, RI

TOWNSHIP OF PORTSMOUTH MAP 68, LOT 74

PROJECT MANAGER	ANKIT DHAR
DESIGNED BY	B. PAULA
DRAWN BY	W. LIN
CHECKED BY	H. NEENAN
APPROVED BY	A. DHAR
PROJECT NUMBER	10328992
	1

EROSION & SEDIMENT CONTROL PLAN

FILENAME SCALE | 1" = 30' SHEET 5 OF 8 C-3

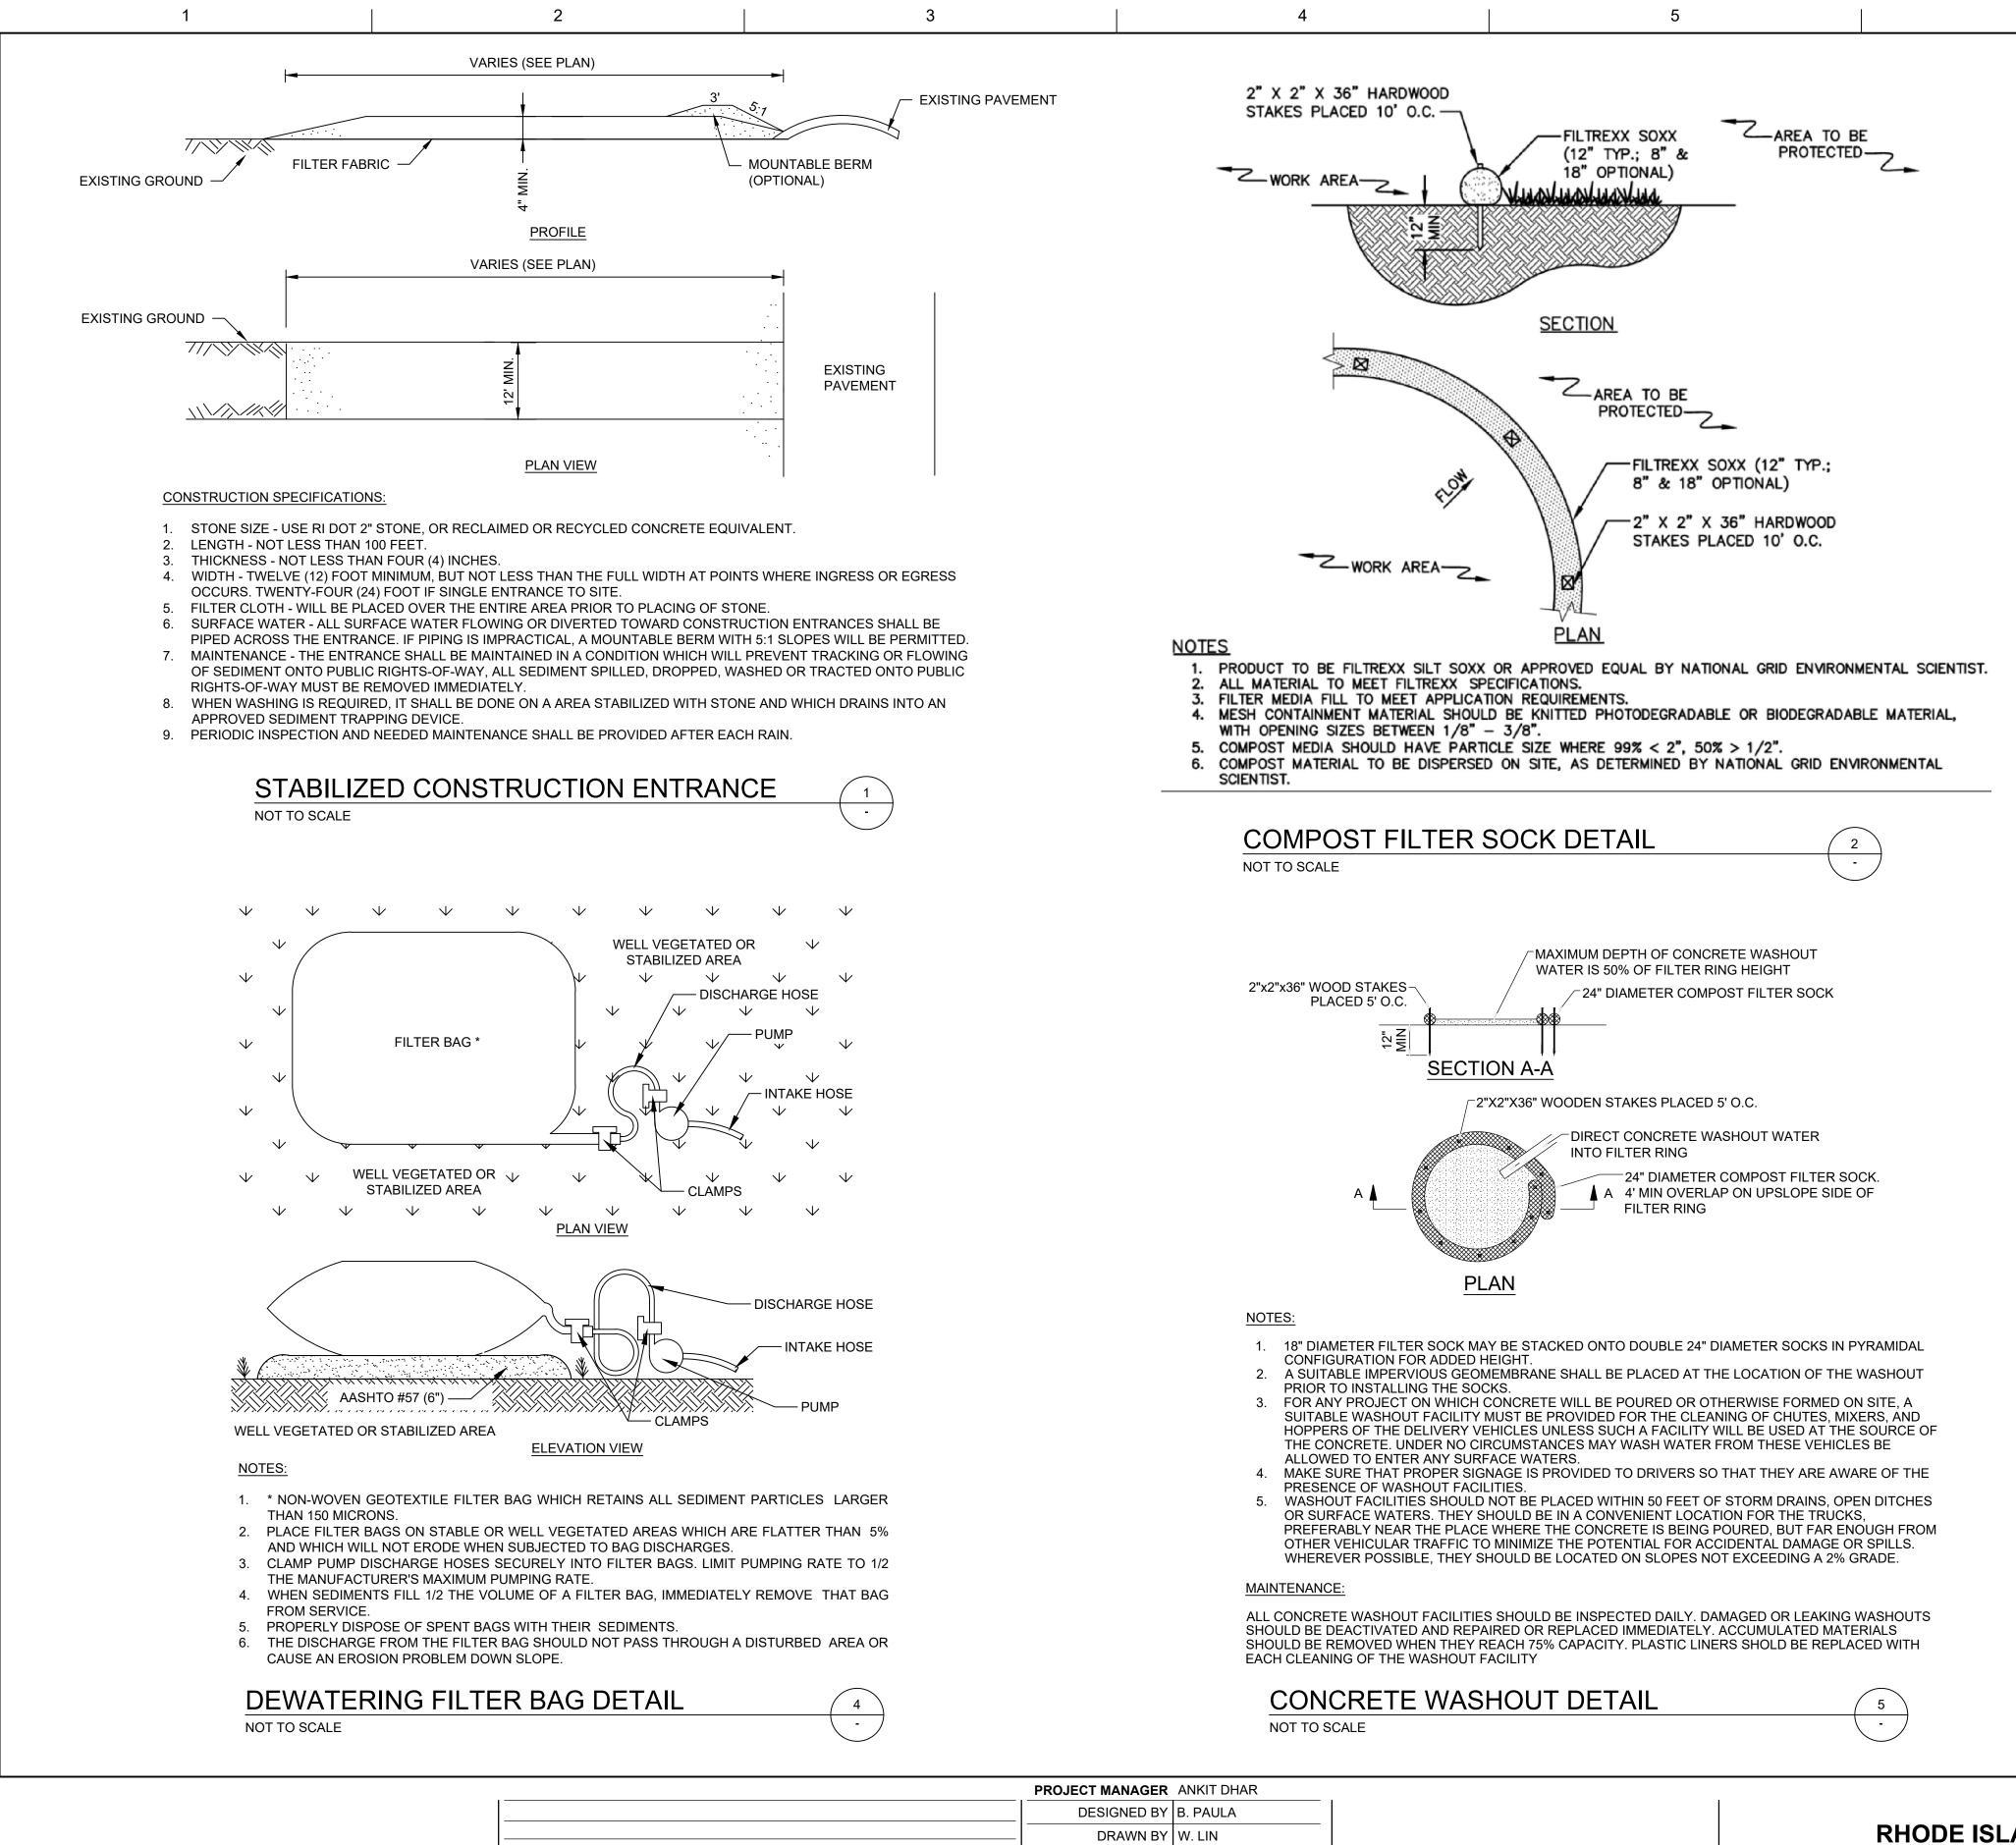


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6	01/12/2024	REVISED CIVIL PLAN SET PER RIDEM COMMENTS

CONCRETE WASHOUT DETAIL	5
NOT TO SCALE	-

PROJECT MANAGER	ANKIT DHAR
DESIGNED BY	B. PAULA
DRAWN BY	W. LIN
CHECKED BY	H. NEENAN
APPROVED BY	A. DHAR
PROJECT NUMBER	10328992
	•

RHODE ISLAND ENERGY AQUIDNECK ISLAND GAS RELIABILITY PROJECT OLD MILL LANE, PORTSMOUTH, RI

TOWNSHIP OF PORTSMOUTH MAP 68, LOT 74

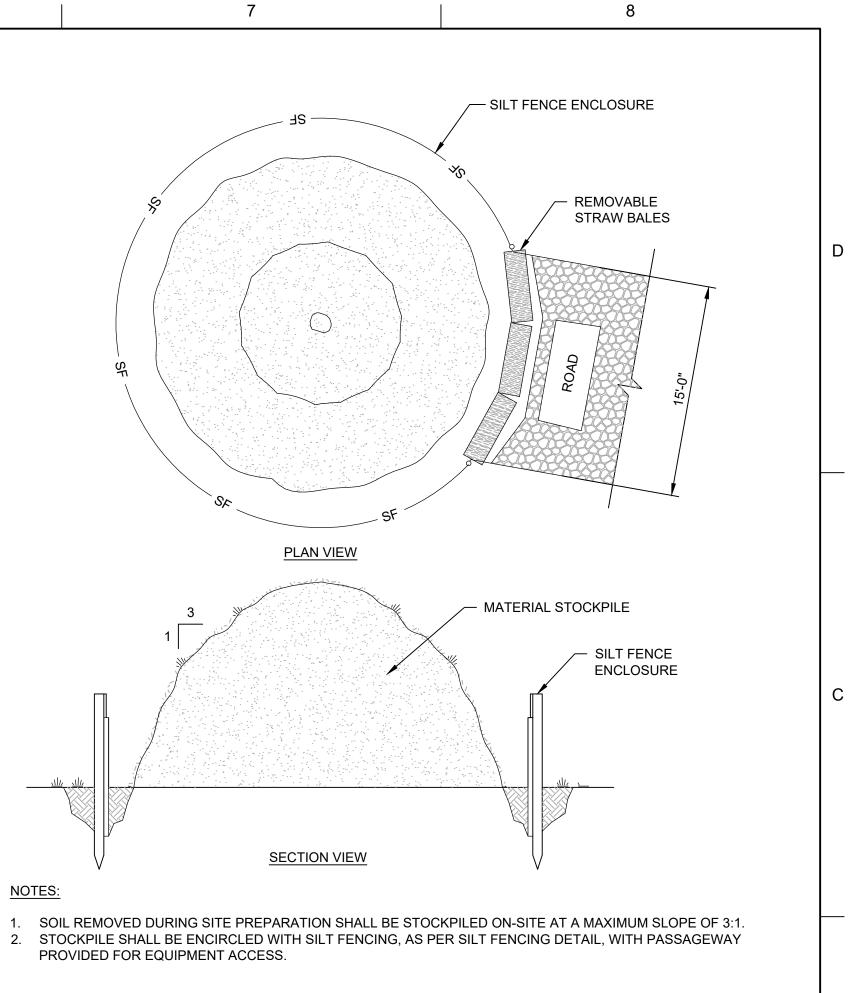

TEMPORARY MATERIAL STOCKPILE DETAIL 3 NOT TO SCALE

EROSION & SEDIMENT CONTROL DETAILS

FILENAME

SCALE NOT TO SCALE

SHEET 6 OF 8

C-4

SEEDING NOTES

- 1. NEW ENGLAND WETMIX TO BE USED WITHIN FLAGGED WETLAND AND INSTALLED VIA SLICE SEEDING.
- FROM NEW ENGLAND WETLAND PLANTS, INC. AMHERST, MASSACHUSETTS

SEEDING: ALWAYS APPLY ON CLEAN BARE SOIL. THE WETLAND SEEDS IN THIS MIX CAN BE HAND SOWN, USED WITH A HAND-HELD SPREADER, OR HYDRO-SEEDED ON LARGE OR HARD TO REACH SITES, AS LONG AS THERE IS NO PERMANENT SNOW COVER. LIGHTLY RAKE TO ENSURE PROPER SOIL-SEED CONTACT. SEEDING CAN TAKE PLACE ON FROZEN SOIL, AS THE FREEZING, THAWING WEATHER OF LATE FALL AND LATE WINTER WILL WORK THE SEED INTO THE SOIL. IF SPRING CONDITIONS ARE DRIER THAN USUAL, WATERING MAY BE REQUIRED. IF PLANTING DURING THE SUMMER MONTHS, WATERING MAY BE REQUIRED FOR AT LEAST 2-3 WEEKS AFTER PLANTING TO ENSURE GERMINATION. A NON-INVASIVE ANNUAL SUCH AS WINTER RYE MAY BE ADDED TO THE MIX TO OBTAIN SOIL STABILIZATION COVER IN THE FALL. DO NOT ADD ANNUAL RYEGRASS, KENTUCKY BLUEGRASS OR PERENNIAL RYEGRASS AS THESE SPECIES ARE VERY AGGRESSIVE AND THEY WILL INHIBIT THE GROWTH OF THE WETLAND SEEDS. A LIGHT MULCH OF CLEAN, WEED FREE STRAW IS RECOMMENDED. NOTE: SEEDS WILL NOT GERMINATE UNDER INUNDATED CONDITIONS. NOT ALL SPECIES WILL GROW IN ALL WETLAND SITUATIONS.

1-201

APPLICATION RATE: 1 LB/2500 SQ. FT.


TYPICAL SPECIES: FOX SEDGE (CAREX VULPINOIDEA), SALLOW SEDGE (CAREX LURIDA), BROOM SEDGE (CAREX SCOPARIA), SENSITIVE FERN (ONOCLEA SENSIBILIS), BLUE VERVAIN(VERBENA HASTATA), HOP SEDGE (CAREX LUPULINA), DARK-GREEN BULRUSH (SCIRPUS ATROVIRENS), NODDING BUR-MARIGOLD (BIDENS CERNUA), BRISTLY SEDGE (CAREX COMOSA), FRINGED SEDGE (CAREX CRINITA), TALL MANNAGRASS (GLYCERIA GRANDIS), WOOL-GRASS (SCIRPUS CYPERINUS), SOFT RUSH (JUNCUS EFFUSUS), SPOTTED JOE-PYE-WEED (EUTROCHIUM MACULATUM), BONESET (EUPATORIUM PERFOLIATUM), AMERICAN WATER-PLANTAIN (ALISMA SUBCORDATUM), NEW ENGLAND ASTER (SYMPHYOTRICHUM NOVAE-ANGLIAE), RATTLESNAKE MANNAGRASS (GLYCERIA CANADENSIS), PURPLE-STEM ASTER (SYMPHYOTRICHUM PUNICEUM), SOFT-STEMMED BULRUSH (SCHOENOPLECTUS TABERNAEMONTANI), BLUEFLAG (IRIS VERSICOLOR), SWAMP MILKWEED (ASCLEPIAS INCARNATA), AND ALLEGHENY MONKEY-FLOWER (MIMULUS RINGENS).

2. SEED MIX TO BE USED IN THE 50-FOOT PERIMETER WETLAND WILL BE COMPRISED OF A NATIVE POLLINATOR MIX.

Common name	Scientific name	Percent composition
Little Bluestem	Schizachyrium scoparium	35.0%
Sundial Lupine	Lupinus perennis	15.0%
Partridge Pea	Chamaecrista fasciculata	15.0%
Round-head Bush Clover	Lespedeza capitata	11.0%
Wild Bergamot	Monarda fistulosa	10.0%
Butterfly Milkweed	Asclepias tuberosa	10.0%
Hyssop-leaved Thoroughwort	Eupatorium hyssopifolium	1.1%
Showy Goldenrod	Solidago speciosa,	1.0%
Gray Goldenrod	Solidago nemoralis	1.0%
Blue Wood (Heartleaf) Aster	Symphyotrichum cordifolium	0.5%
False Indigo	Baptisia tinctoria	0.2%
New York Ironweed	Vernonia noveboracensis	0.2%


APPLY POLLINATOR MIX AT 5LBS/ACRE.

NOTE: THIS MIX MAY BE VARIED BASED ON SEED AVAILABILITY. THE ADDITION OF OTHER NATIVE SPECIES, INCLUDING GRASSES IS ENCOURAGED. THE MIX SHALL PRODUCE A HIGH QUALITY PERENNIAL MIX THAT IS HIGHLY ATTRACTIVE TO POLLINATORS. USE SLICE SEEDING TO INSTALL THE SEED.

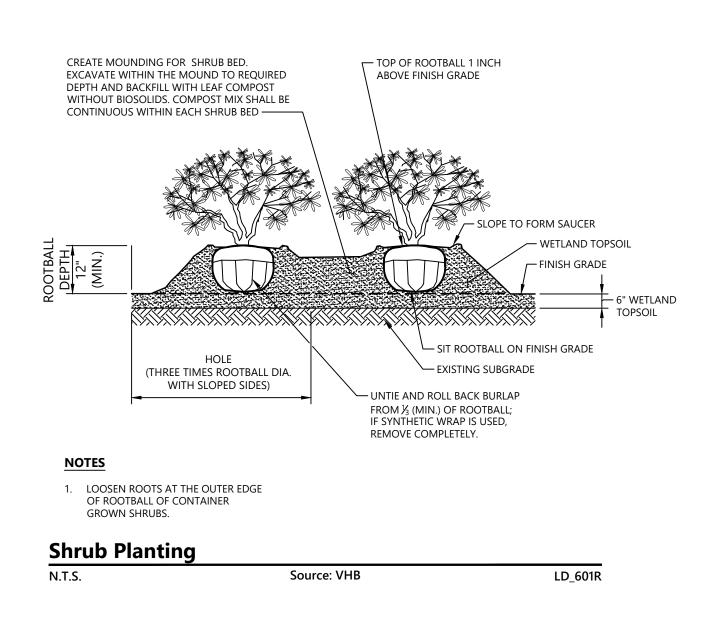

<u>SHRUBS</u> IV SC SD SA	<u>SCIENTIFIC NAME</u> Ilex verticillata Sambucus canadensis Salix discolor Swida amomum	COMMON NAME↔Winterberry↔American Elderberry→Pussy Willow→⊙Silky Dogwood	<u>SIZE</u> 2 - 3' He 2 - 3' He 2 - 3' He 2 - 3' He
<u>TREES</u>	SCIENTIFIC NAME	COMMON NAME	<u>SIZE</u>
AR	Acer rubrum	Red Maple	3' Heigh

Source: 2021 NearMap Aerial Photograph

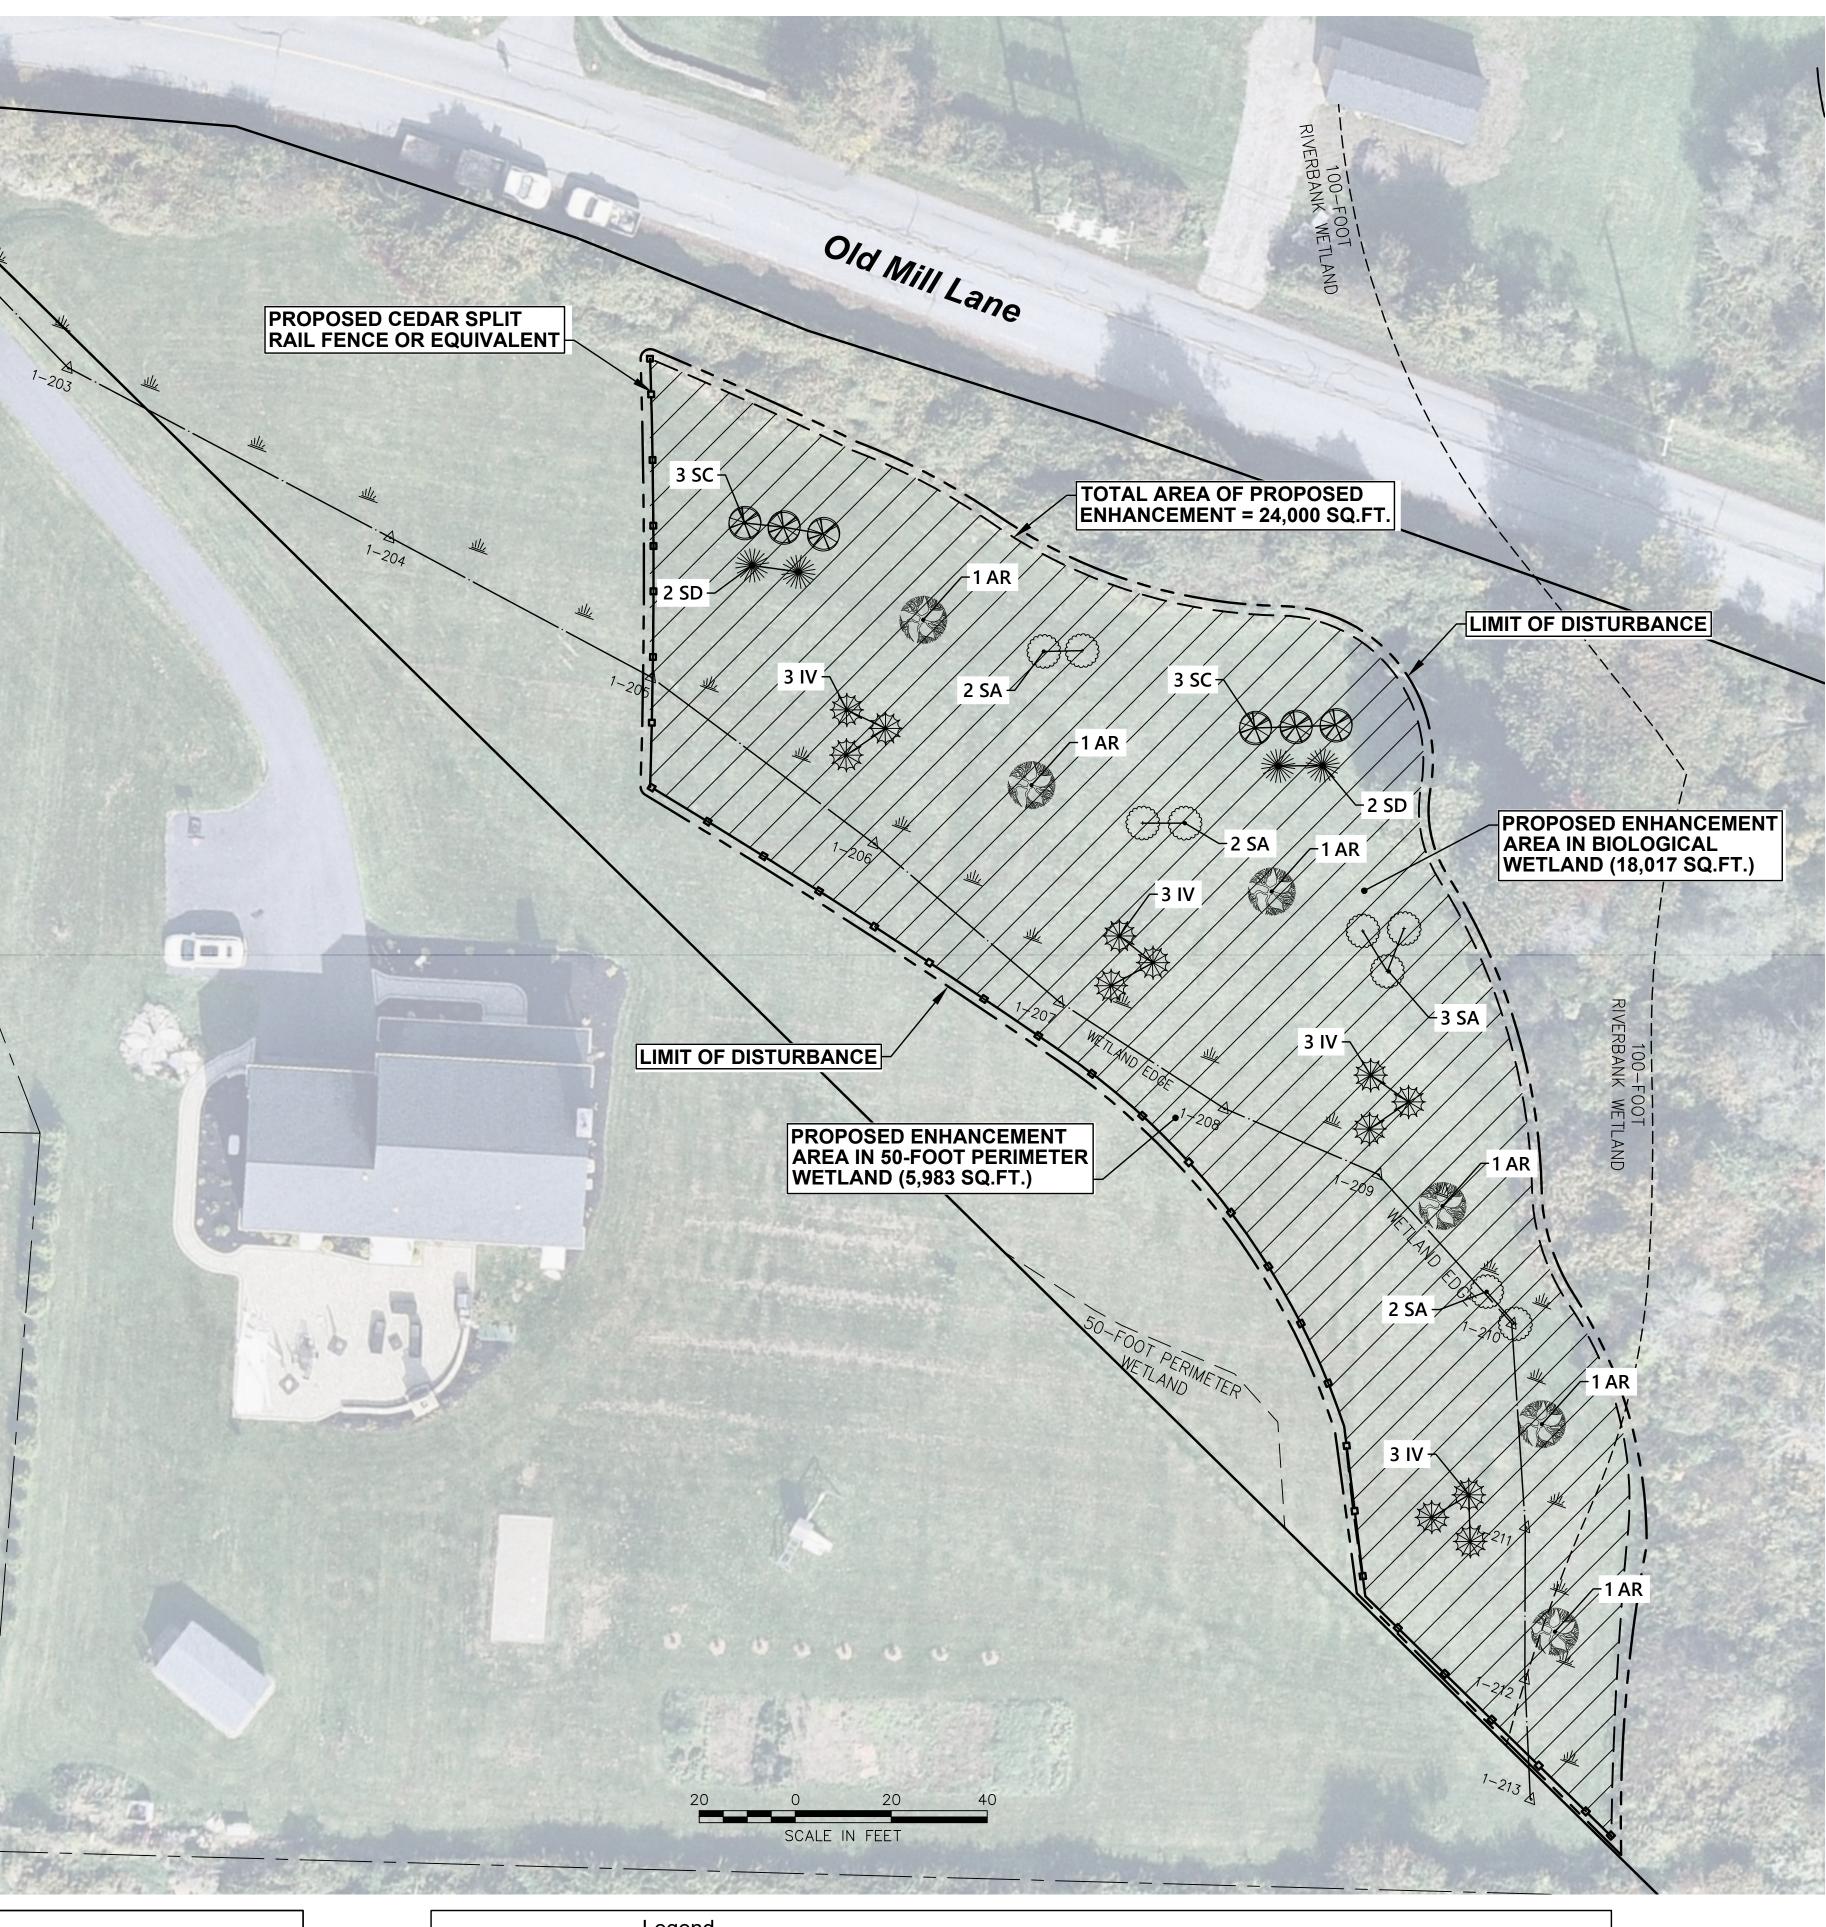

Height Height Height Height	<u>QUANTITY</u> 12 6 4 9		
ght	QUANTITY 6		

	Legend	
7	Verified Wetland Flag	
	Verified Wetland Edge	o
	50' Perimeter Wetland	
	100' Riverbank Wetland	

Proposed Enhancement Area Proposed Cedar Split Rail Fence or Equivalent ----- Proposed Limit of Disturbance




Suite 400 Providence, RI 02903 401.272.8100


Old Mill Lane Wetland Mitigation/Enhancement Plan

Old Mill Lane Portsmouth, Rhode Island


No.	Revision	Date	Appvd.
1	RESPONSE TO RIDEM'S DEC. 12, 2022 C	OMMENTS	09-29-2023
2	RIDEM COMMENT RESPONSE		11-15-2023
Desigr	ned by	Checked b	у
Issued	for	Date	
RII	DEM Application to	6-	22-2022
	ter Freshwater Wetlan	ds	
		0.0	
Draw	<i>i</i> ng Title		
Ρ	lanting Plan		


P-** SHEET 7 of 8 Project Number **73195.00**

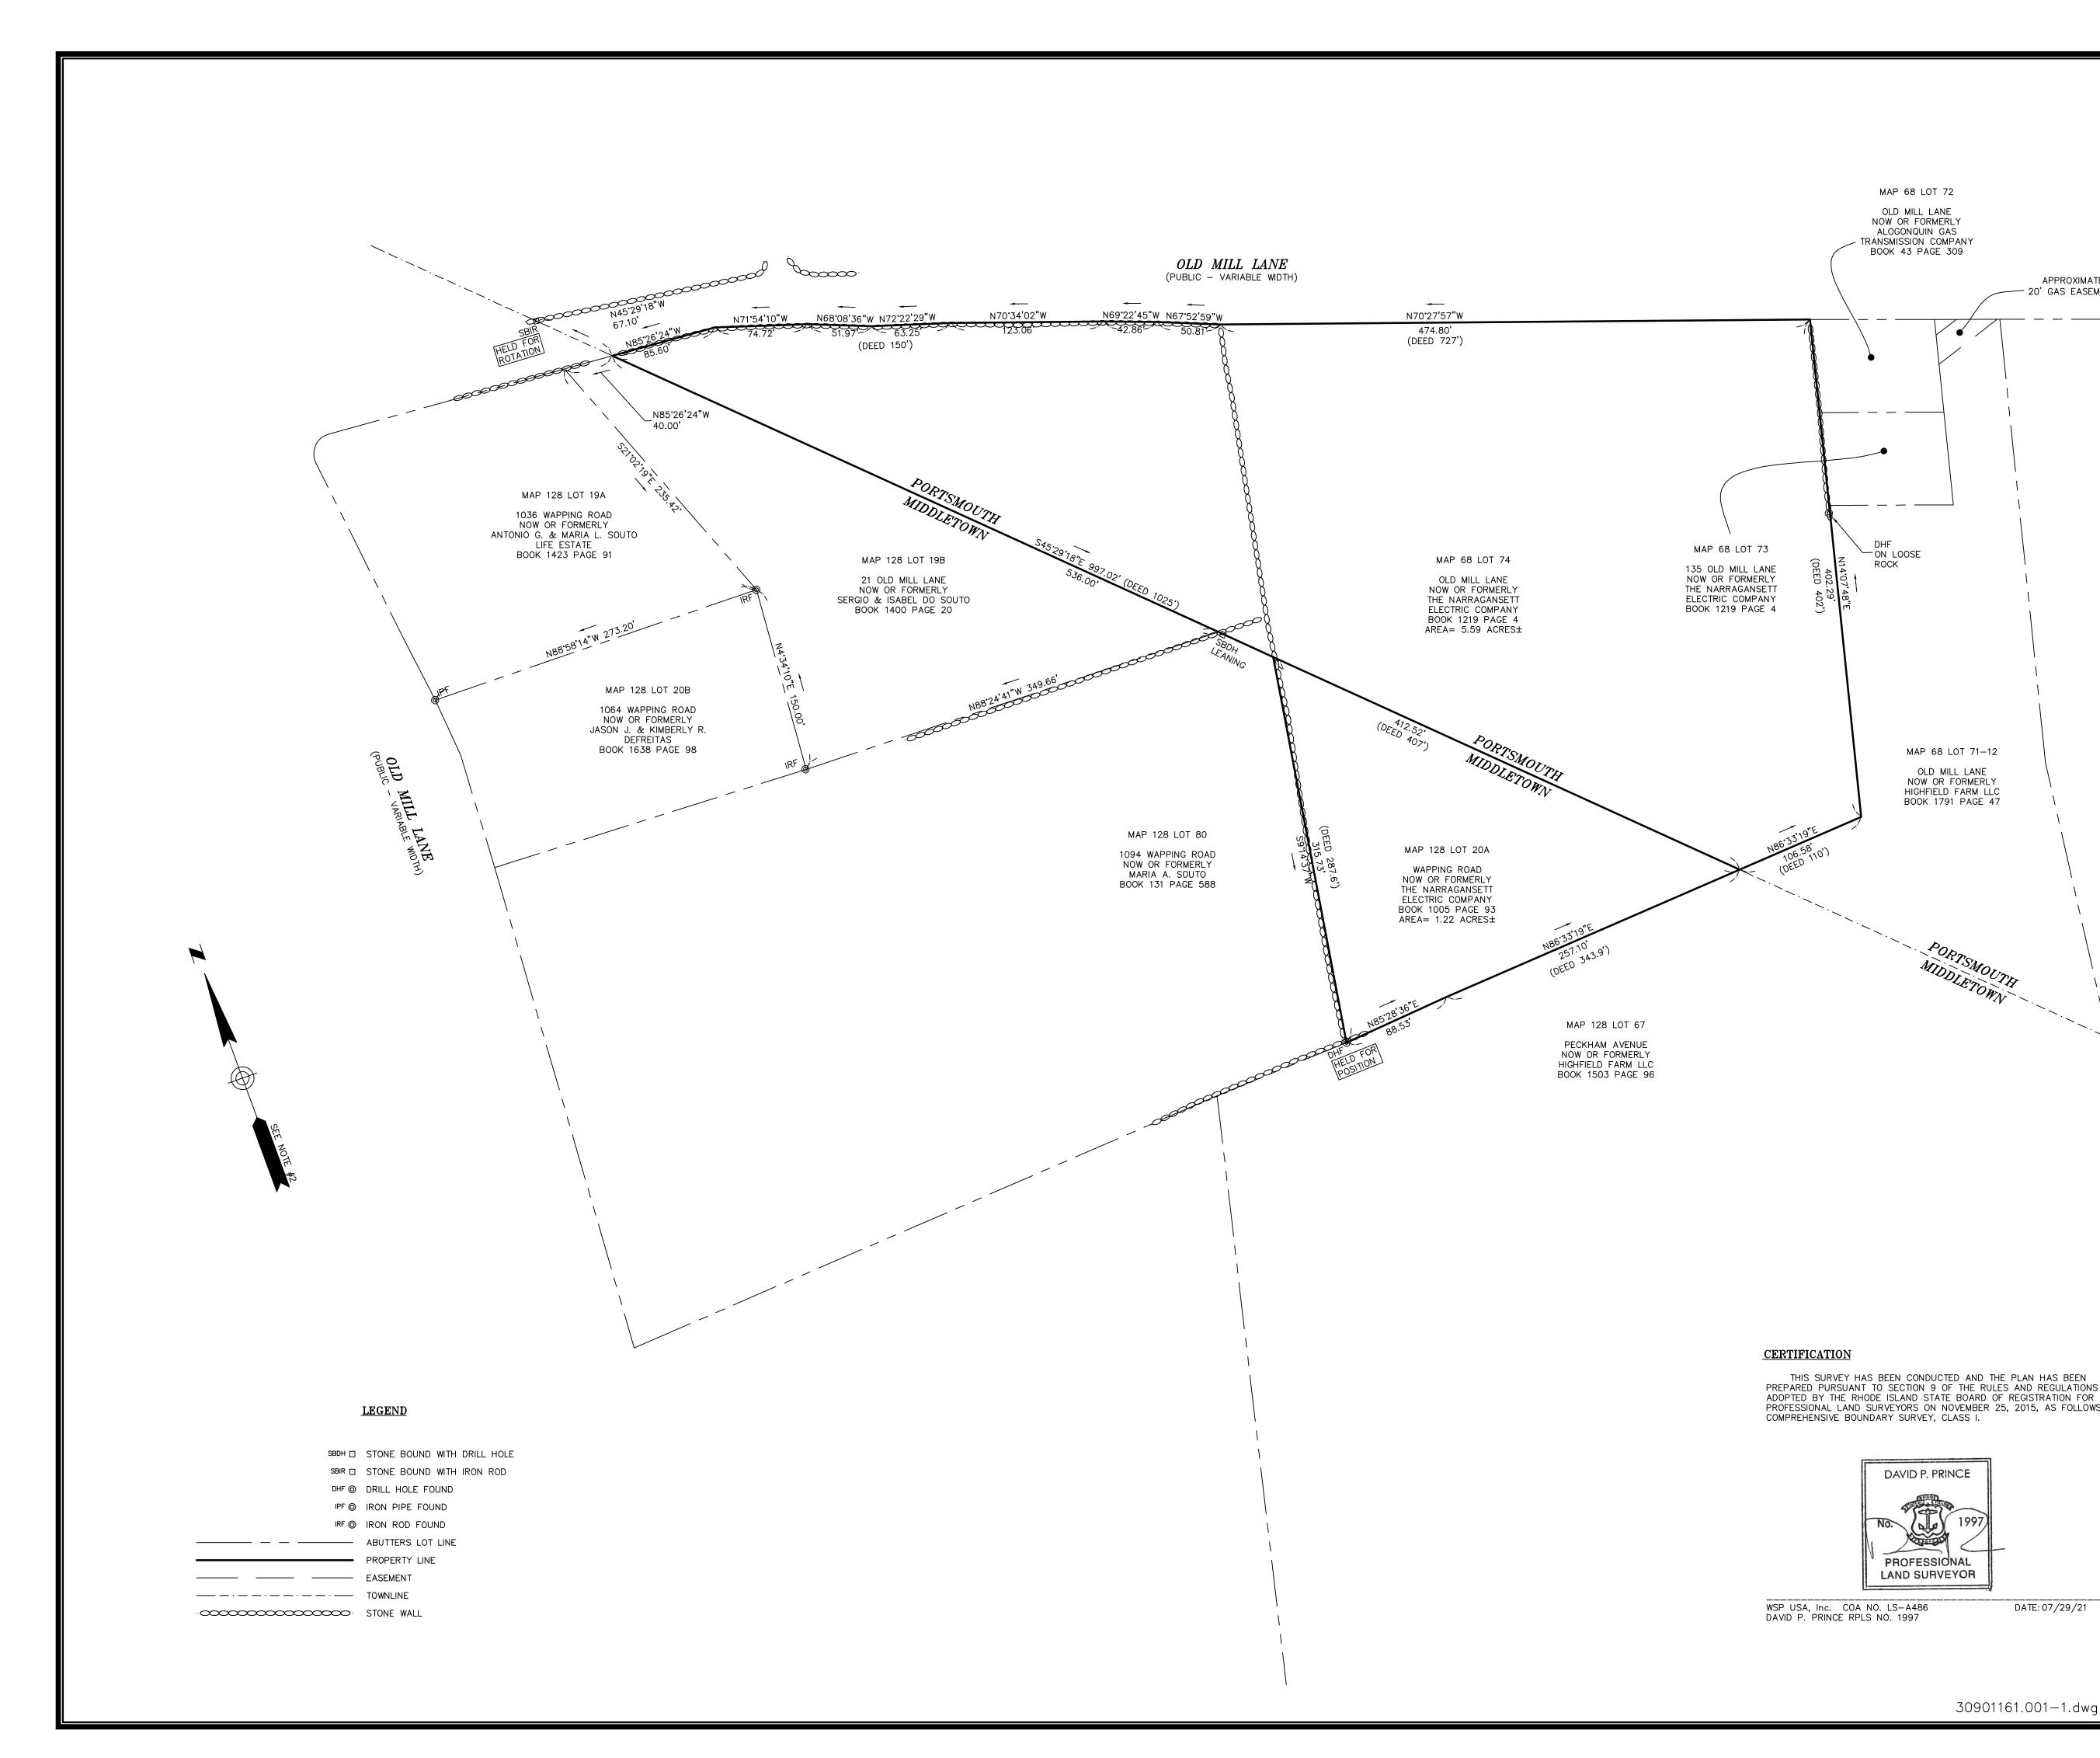

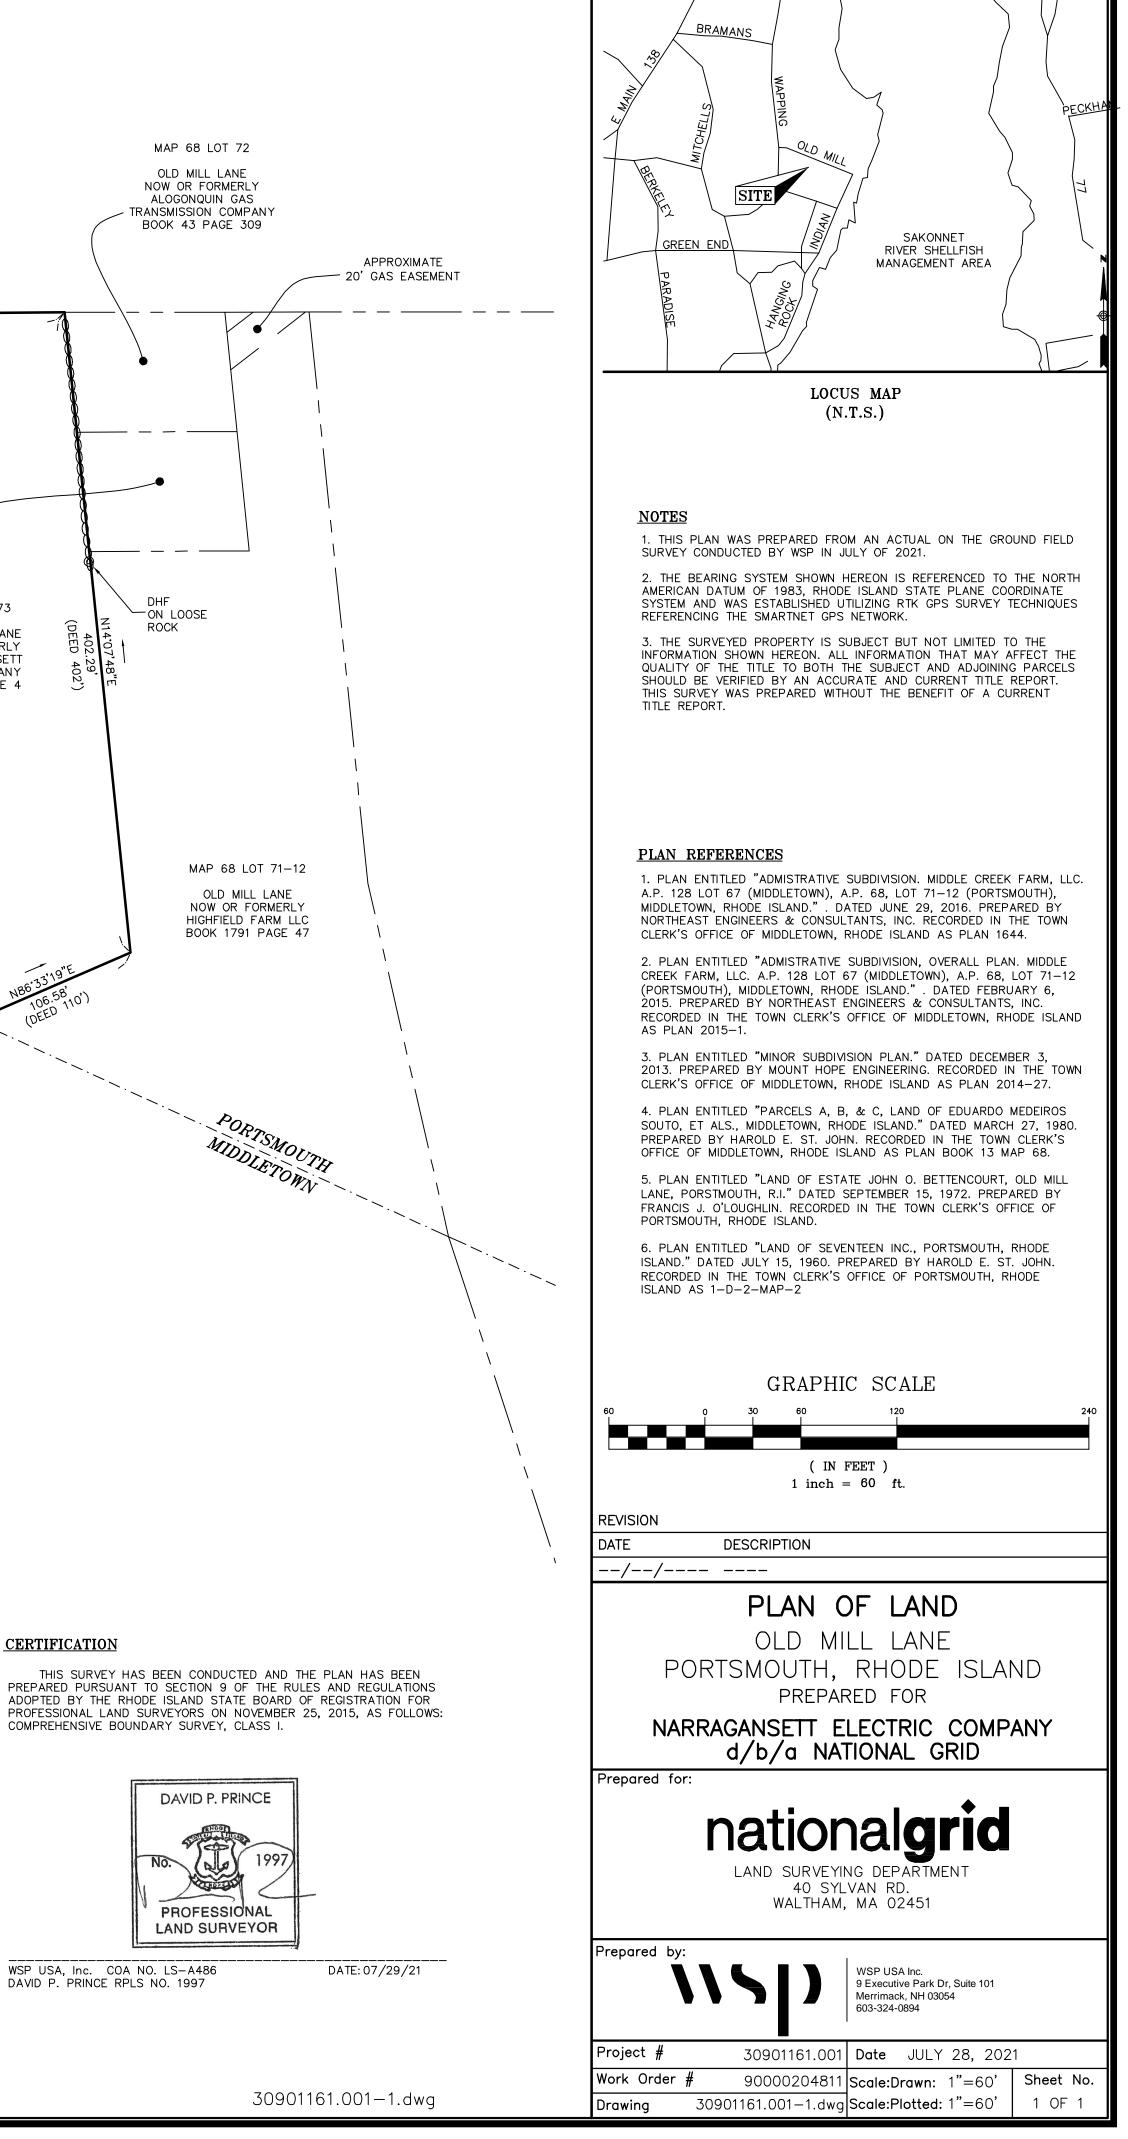

Sheet 8 of 8

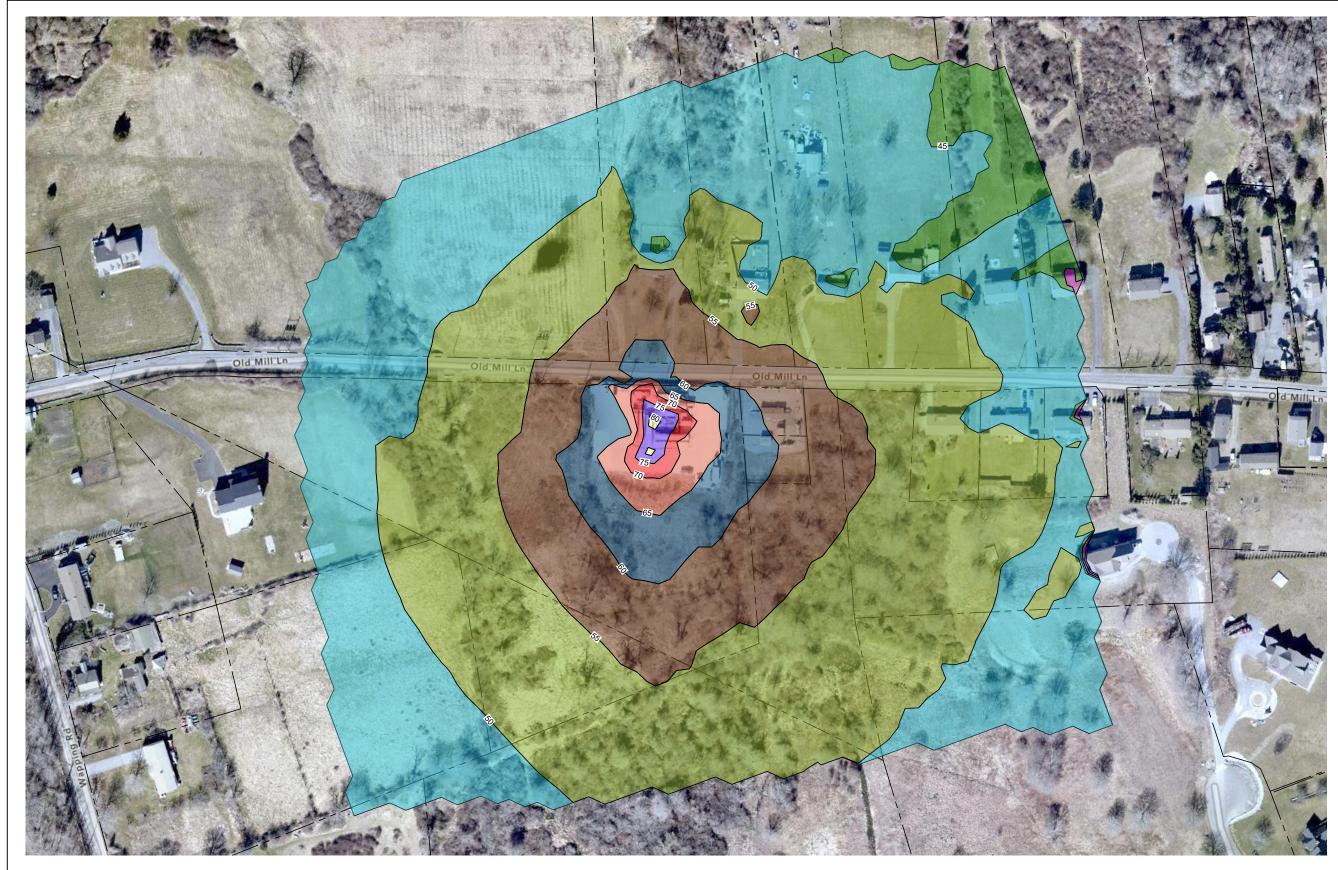

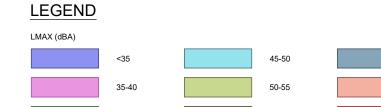

55-60

40-45

60-65

65-70

70-75

75-80

>80



SHEET TITLE (Lmax) SCALE **1" = 150'**



NOTES:

- AERIAL IMAGE TAKEN FROM 1. RIDEM GIS - RI MAPS & AERIAL PHOTOS AND NOT TO SCALE.
- PROPERTY LINE LOCATIONS ARE APPROXIMATED BASED 2. ON MUNICIPAL GIS WEBVIEWERS FROM CITY OF PORTSMOUTH, RI GIS AND CITY OF MIDDLETOWN, RI GIS, TOWN OF PORTSMOUTH PLAT MAPS, AND TOWN OF MIDDLETOWN PLAT MAPS.

PROJECT TITLE AQUIDNECK ISLAND GAS RELIABILITY PROJECT

OPERATIONAL NOISE CONTOURS; EXISTING CASE


PROJECT NUMBER 10328992

PROJECT MANAGER

DATE **07/26/2023**





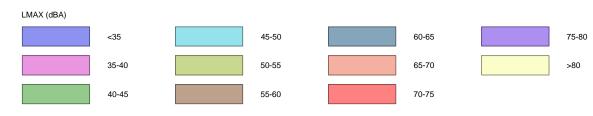





NOTES:

- AERIAL IMAGE TAKEN FROM 1. RIDEM GIS - RI MAPS & AERIAL PHOTOS AND NOT TO SCALE.
- PROPERTY LINE LOCATIONS ARE APPROXIMATED BASED 2. ON MUNICIPAL GIS WEBVIEWERS FROM CITY OF PORTSMOUTH, RI GIS AND CITY OF MIDDLETOWN, RI GIS, TOWN OF PORTSMOUTH PLAT MAPS, AND TOWN OF MIDDLETOWN PLAT MAPS.


PROJECT TITLE AQUIDNECK ISLAND GAS RELIABILITY PROJECT

SHEET TITLE 500 MSCFH Vaporizer and Pump Trailer Operation-Noise Contour Map


PROJECT NUMBER 10328992

PROJECT MANAGER

DATE **03/28/2023**

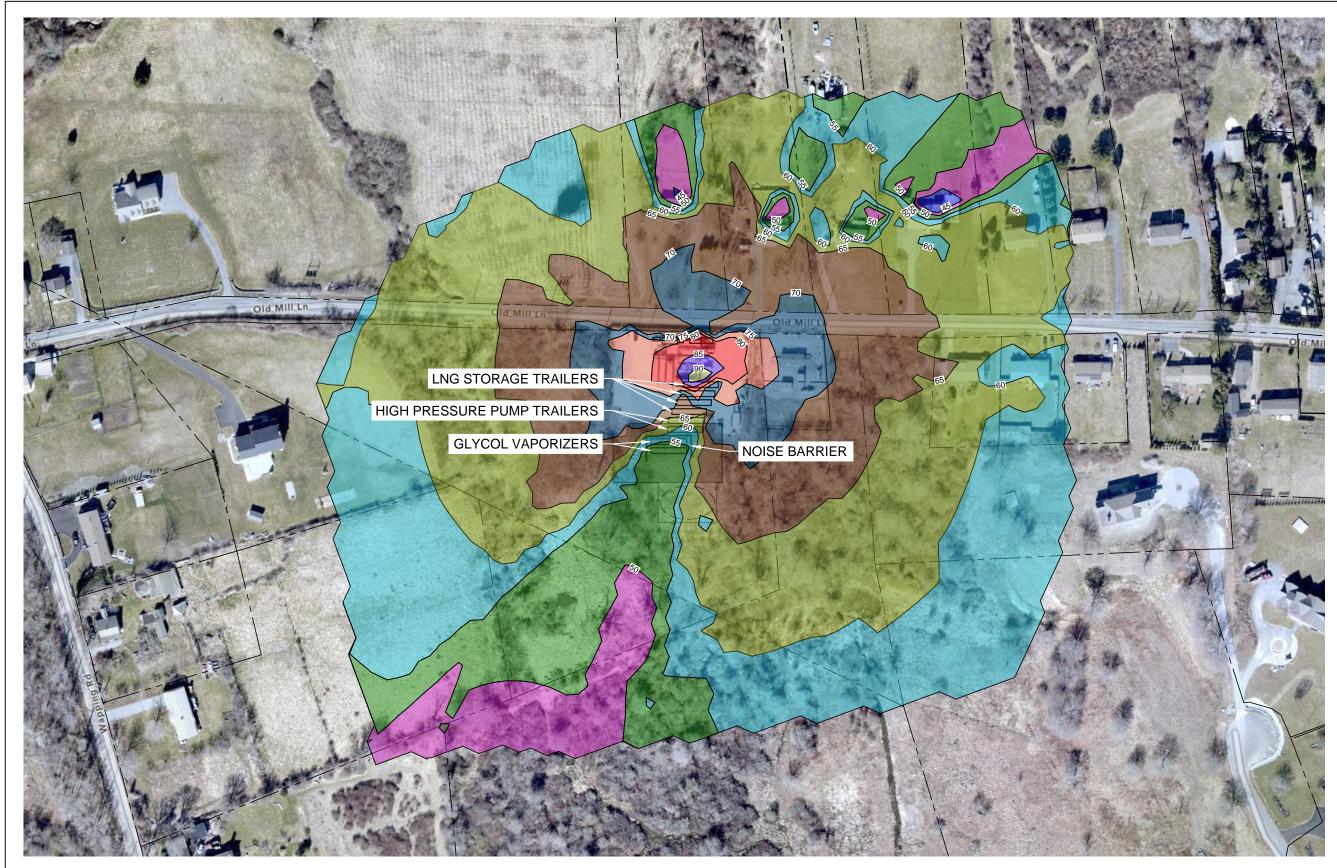



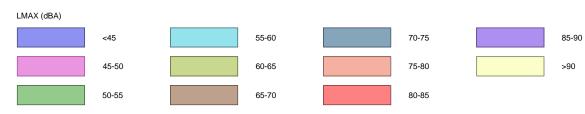

H

SCALE 1" = 150'



NOTES:

- AERIAL IMAGE TAKEN FROM RIDEM GIS - RI MAPS & AERIAL PHOTOS AND NOT TO SCALE.
- PROPERTY LINE LOCATIONS ARE APPROXIMATED BASED 2. ON MUNICIPAL GIS WEBVIEWERS FROM CITY OF PORTSMOUTH, RI GIS AND CITY OF MIDDLETOWN, RI GIS, TOWN OF PORTSMOUTH PLAT MAPS, AND TOWN OF MIDDLETOWN PLAT MAPS.

PROJECT TITLE AQUIDNECK ISLAND GAS RELIABILITY PROJECT

SHEET TITLE Storage Tank Cooldown - Noise Contour Map

PROJECT NUMBER 10328992

PROJECT MANAGER

DATE **06/21/2023**