


PLAN
SCALE: 1"=100'

ENTRY POINT @ 12°
STA. 1+42.43
ELEV. 6.59

EXIT POINT @ 16°
STA. 12+27.57
ELEV. 6.94

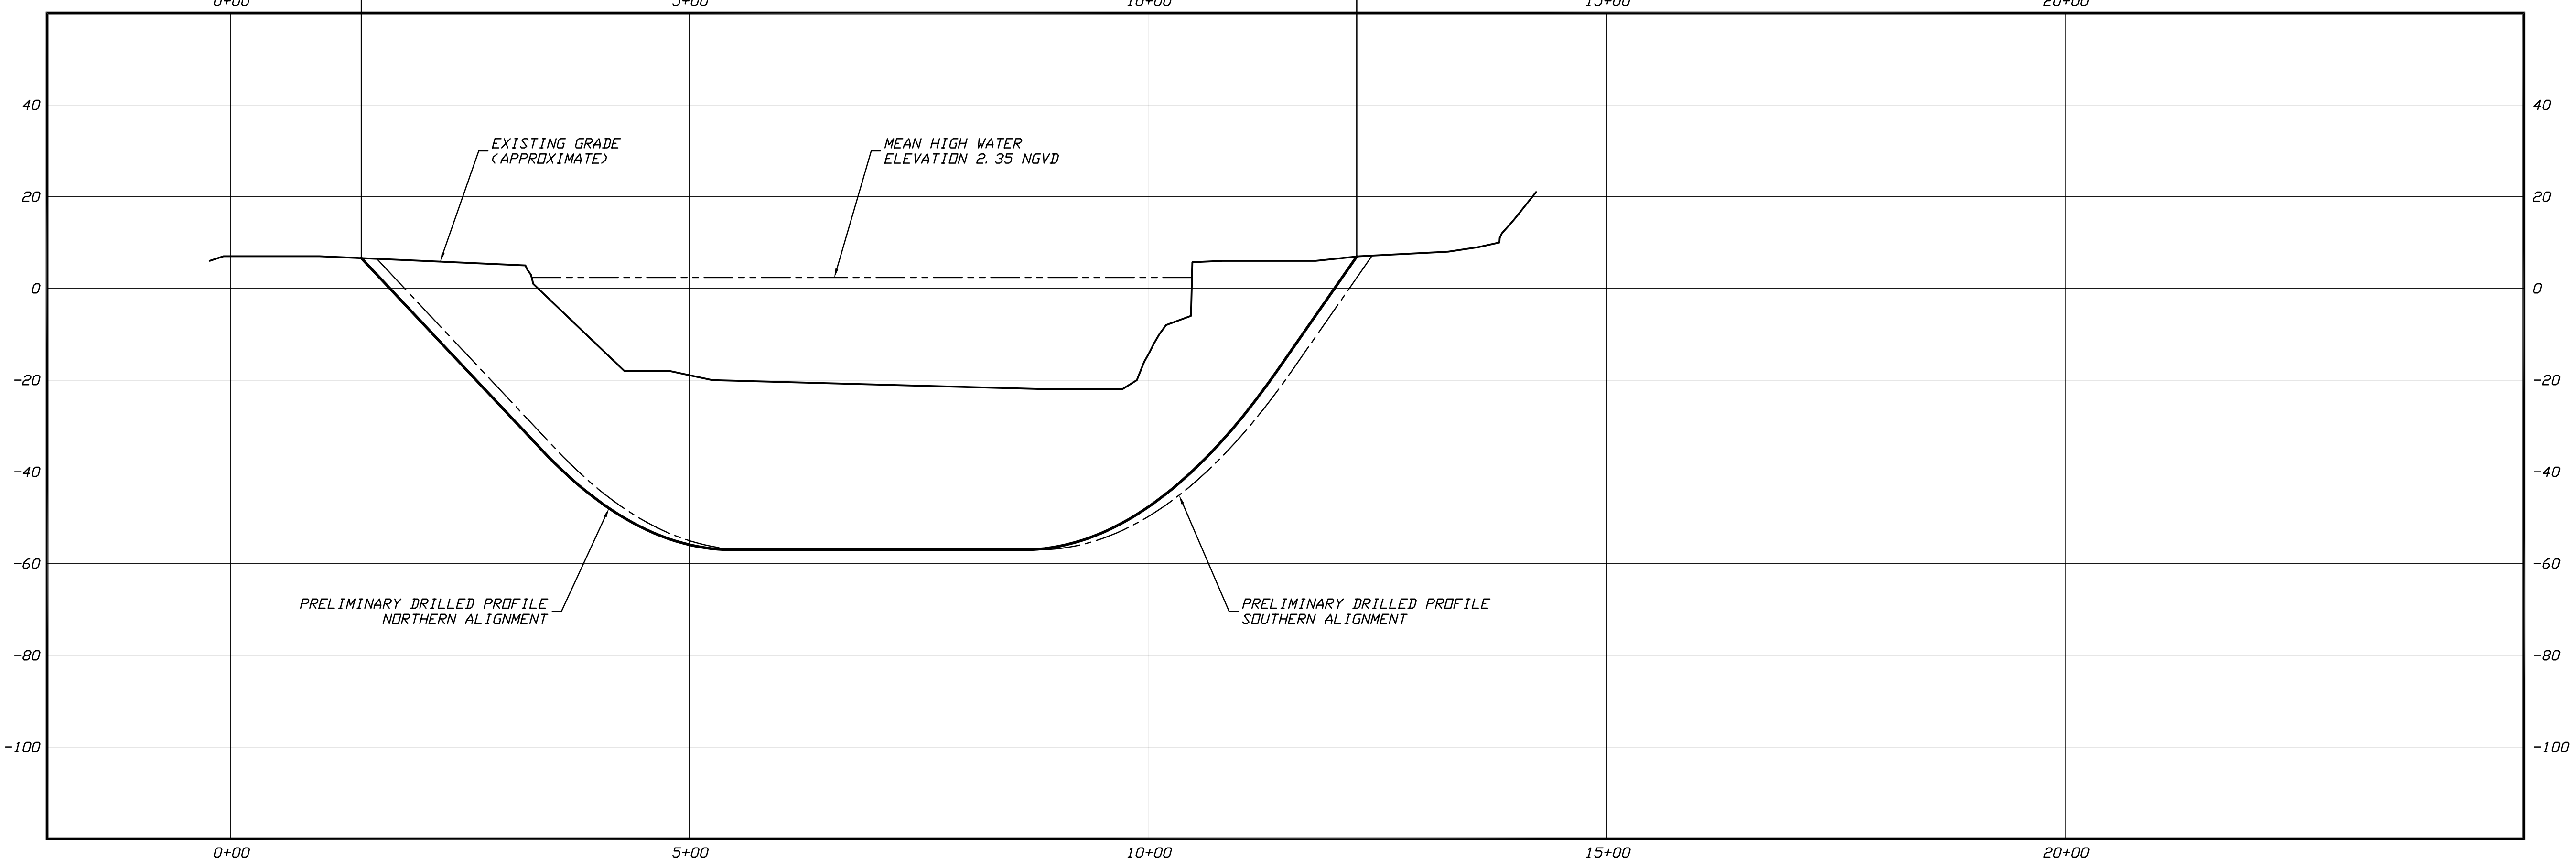

PROFILE
SCALE: 1"=100' HORIZONTAL
1"=20' VERTICAL

GENERAL LEGEND
● DRILLED PATH ENTRY/EXIT POINT


NOT FOR CONSTRUCTION

PRELIMINARY PLAN AND PROFILE - HDD ALIGNMENT OPTION 1 NARAGANSETT ELECTRIC E-183 RELOCATION PROJECT PROPOSED PROVIDENCE RIVER CABLE CROSSING BY HORIZONTAL DIRECTIONAL DRILLING			
LOCATION:	PROVIDENCE, RHODE ISLAND	CHECKED	APPROVED
DATE	06/20/06	SCALE	AS SHOWN
DRAWN	JSP	DRAWING LABEL	PROV_OPTION1
		REVISION	1

NO.	DATE	REVISION DESCRIPTION	BY	CHKD	APP.
1	07/24/06	REVISE DRILLED ALIGNMENTS TO ACCOMMODATE MANHOLES	JSP		

John D. Hair, P.E.
Consulting Engineer
2121 South Columbia Avenue
Suite 101
Tulsa, Oklahoma 74114

PROJECT NO.
PDC\0409
SHEET NO.
2

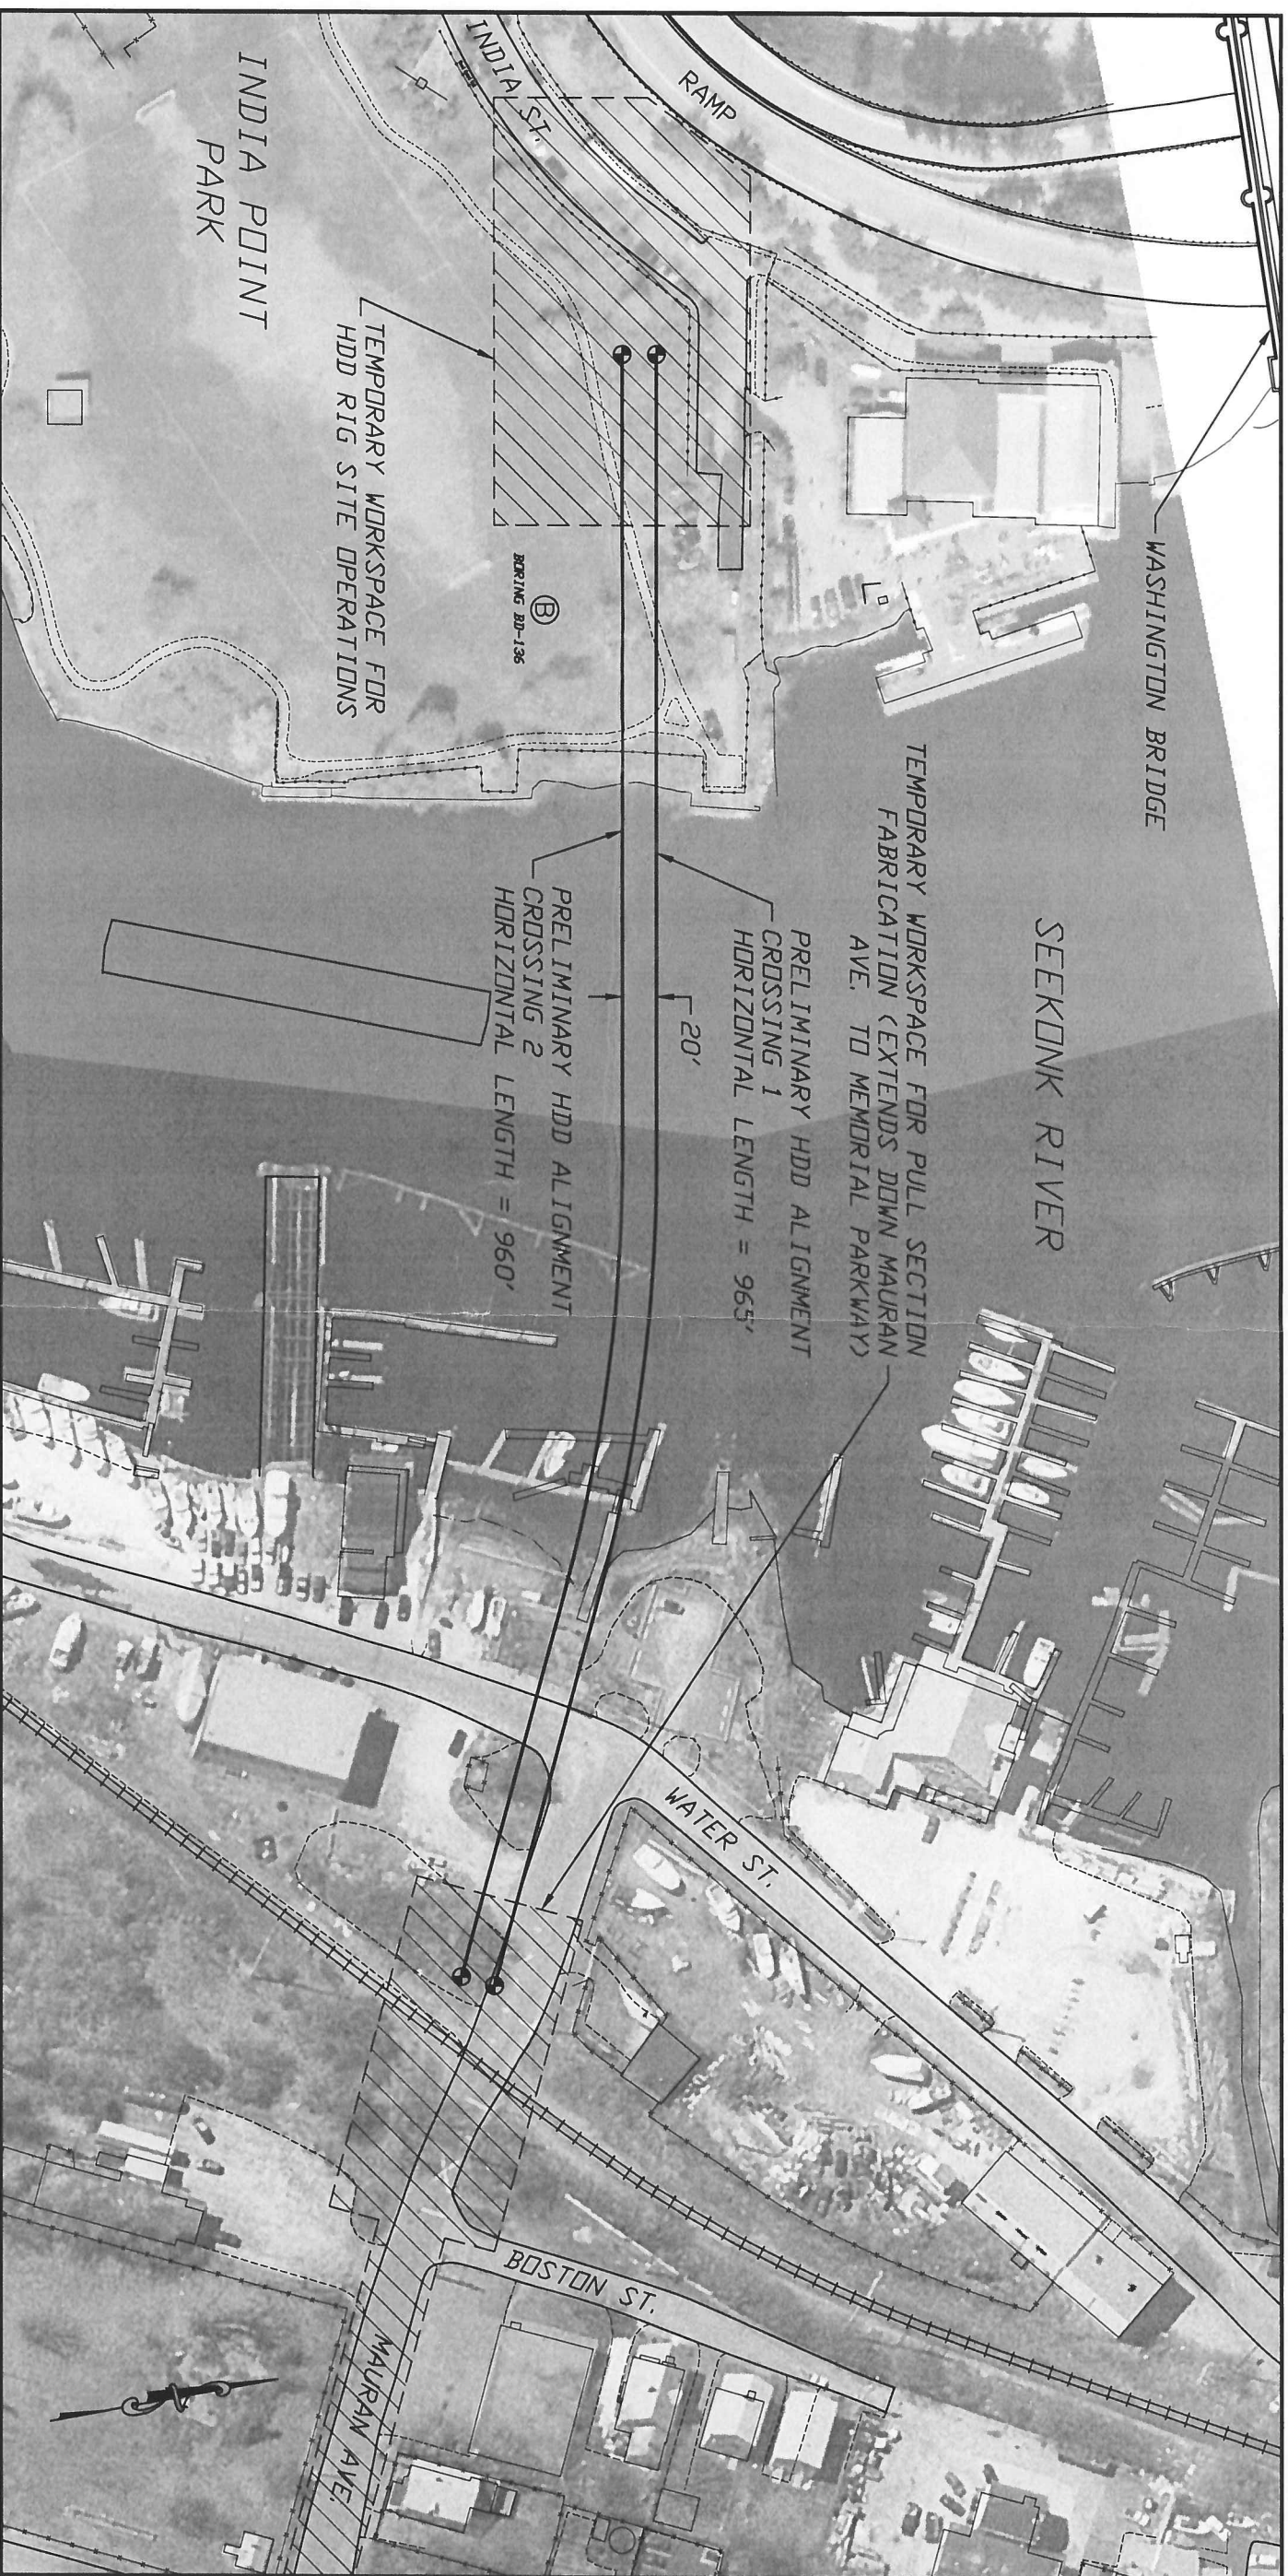

- LEGEND**
- PRELIMINARY HDD ENDPPOINT
 - ⓑ APPROXIMATE LOCATION OF EXISTING BORING

PLAN
SCALE: 1"=100'



John D. Hair, P.E.
Consulting Engineer

2121 South Columbia Avenue
Suite 101
Tulsa, Oklahoma 74114

NO.	DATE	REVISION DESCRIPTION	BY	CHK'D	APP.

PRELIMINARY PLAN
NARRAGANSETT ELECTRIC E-183 RELOCATION
SEEKONK RIVER CABLE CROSSING BY
HORIZONTAL DIRECTIONAL DRILLING

LOCATION:	PROVIDENCE AND EAST PROVIDENCE, RHODE ISLAND
DRAWN	JSP
DATE	11/18/04
CHECKED	
APPROVED	
SCALE	AS SHOWN
DRAWING LABEL	SEEKONK_PLAN
REVISION	0

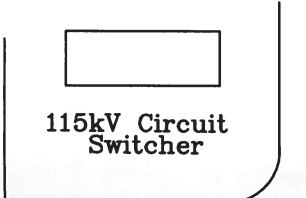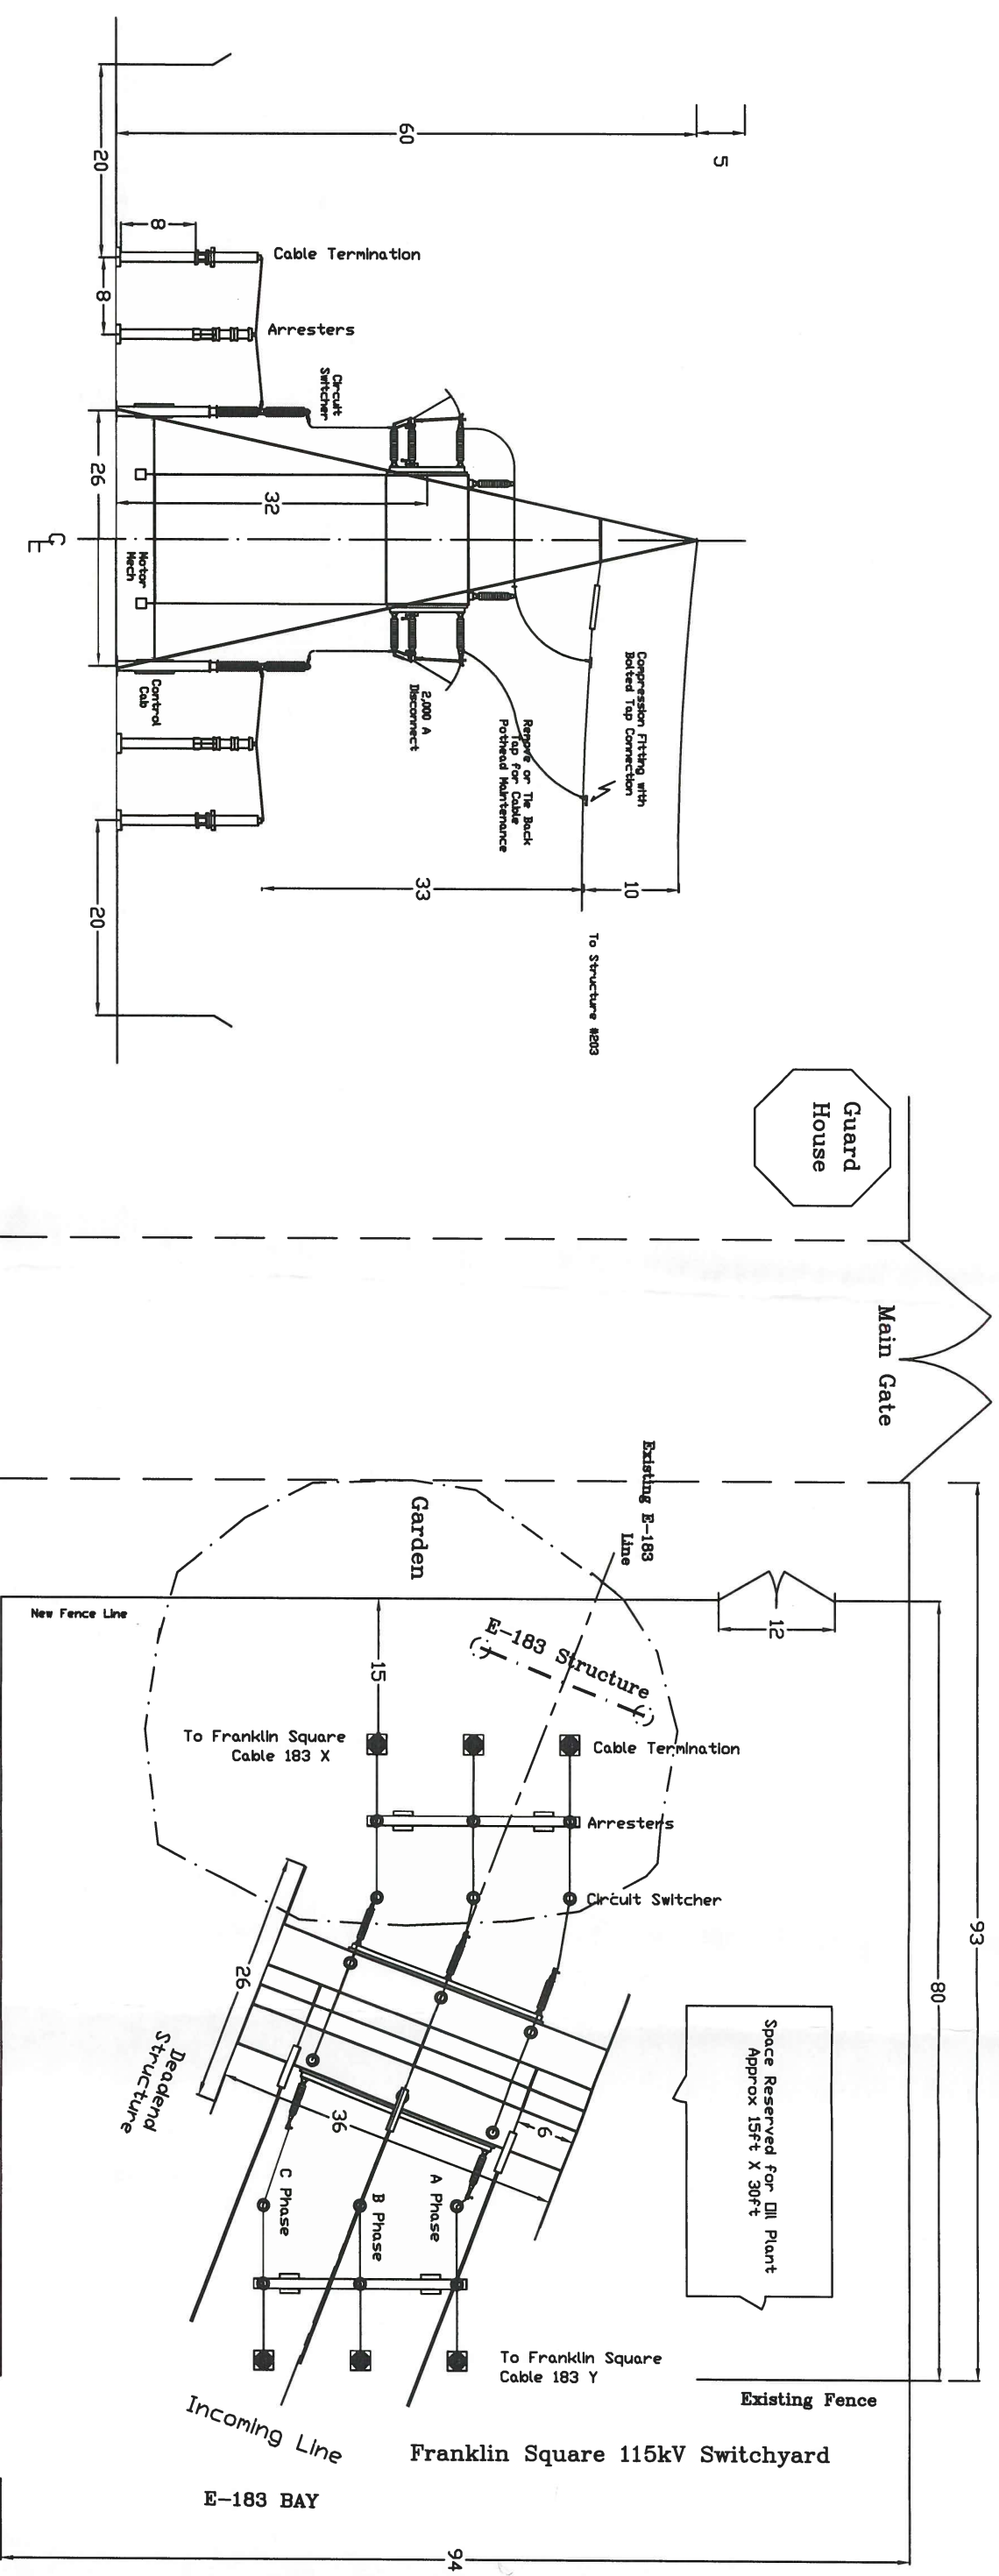

Point Street Access

Franklin Square Distribution Substation

- Notes:**
1. All Dimensions are in Feet
 2. Protective relays, dc and ac control power, RTU connections, etc. will be supplied from or connected to the Franklin Square control room.
 3. The new deadend structure is angled to intercept the existing substation connection in a similar manner to the present overhead transmission line. The angle will also permit the structure to be installed and the E-183 overhead to remain in service using jumpers, while the remaining equipment and cables are installed.

REV.	DATE	DESCRIPTION	BY	CHK	DATE	DESCRIPTION	BY	CHK	DATE
7									
6									
5									
4					0	3/24 ORIGINAL ISSUE			



Sheet 2 of 2

The Narragansett Electric Company
 Providence, Rhode Island


Underground Alternative
 Franklin Square Transition Station
 EFSB Dkt SB-2003-01
 ATTACHMENT NO. REV

SCALE: DMC - XX A

ANSI D 227 X 34"

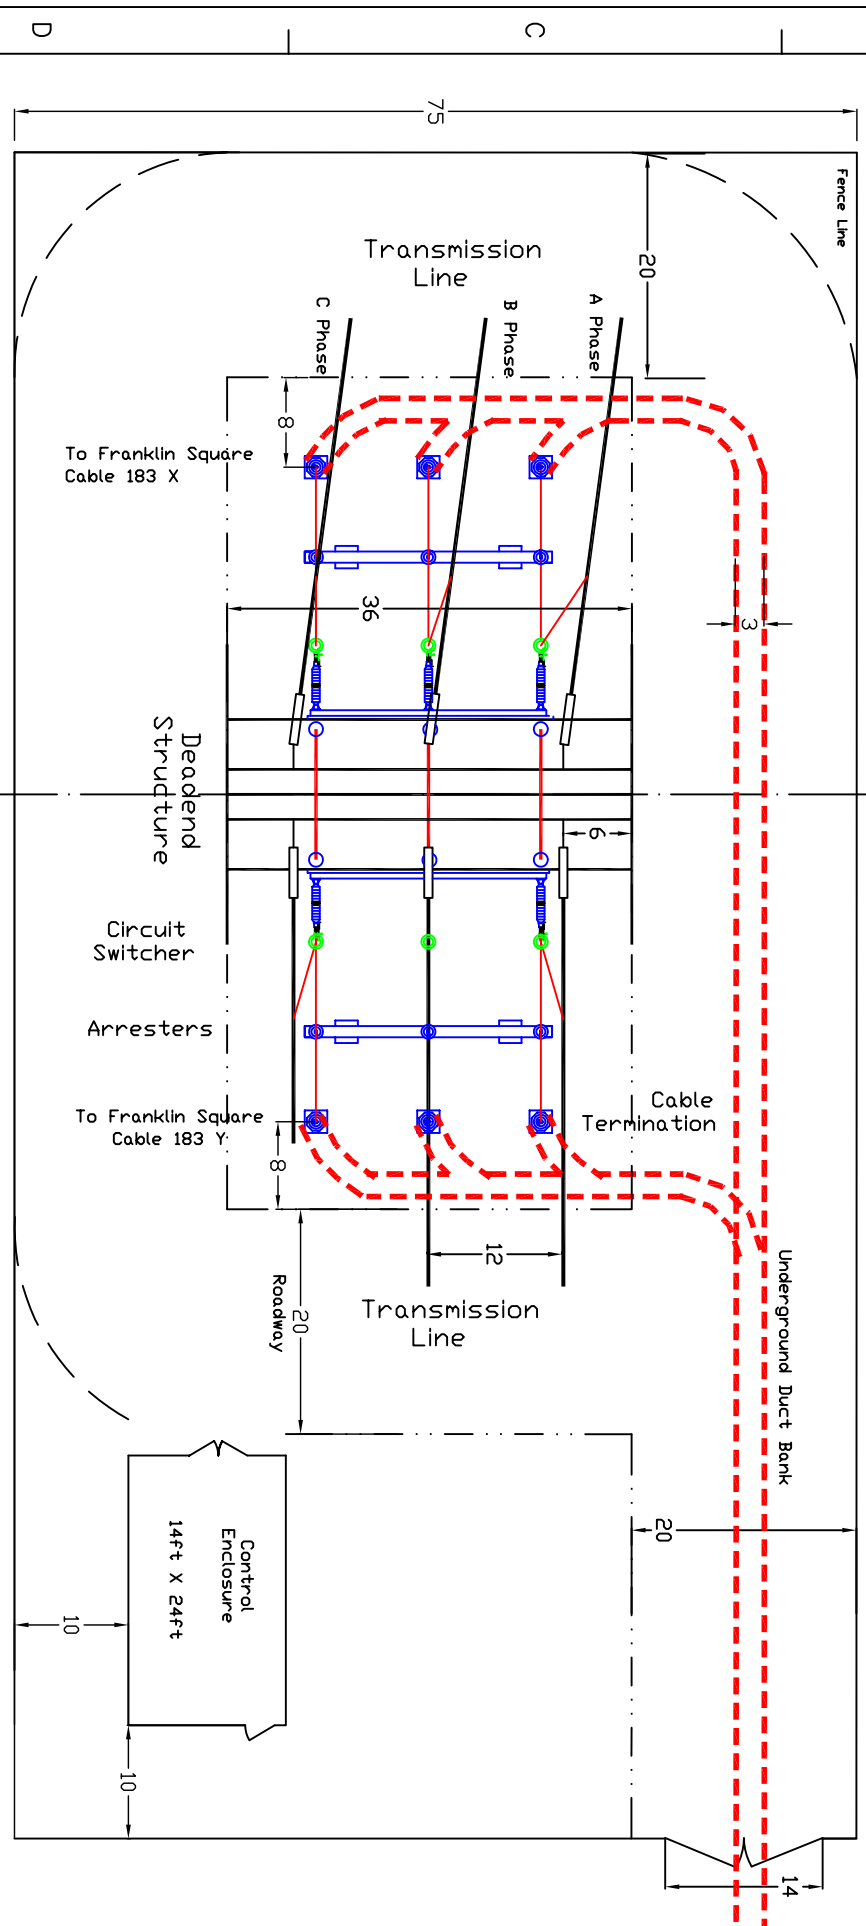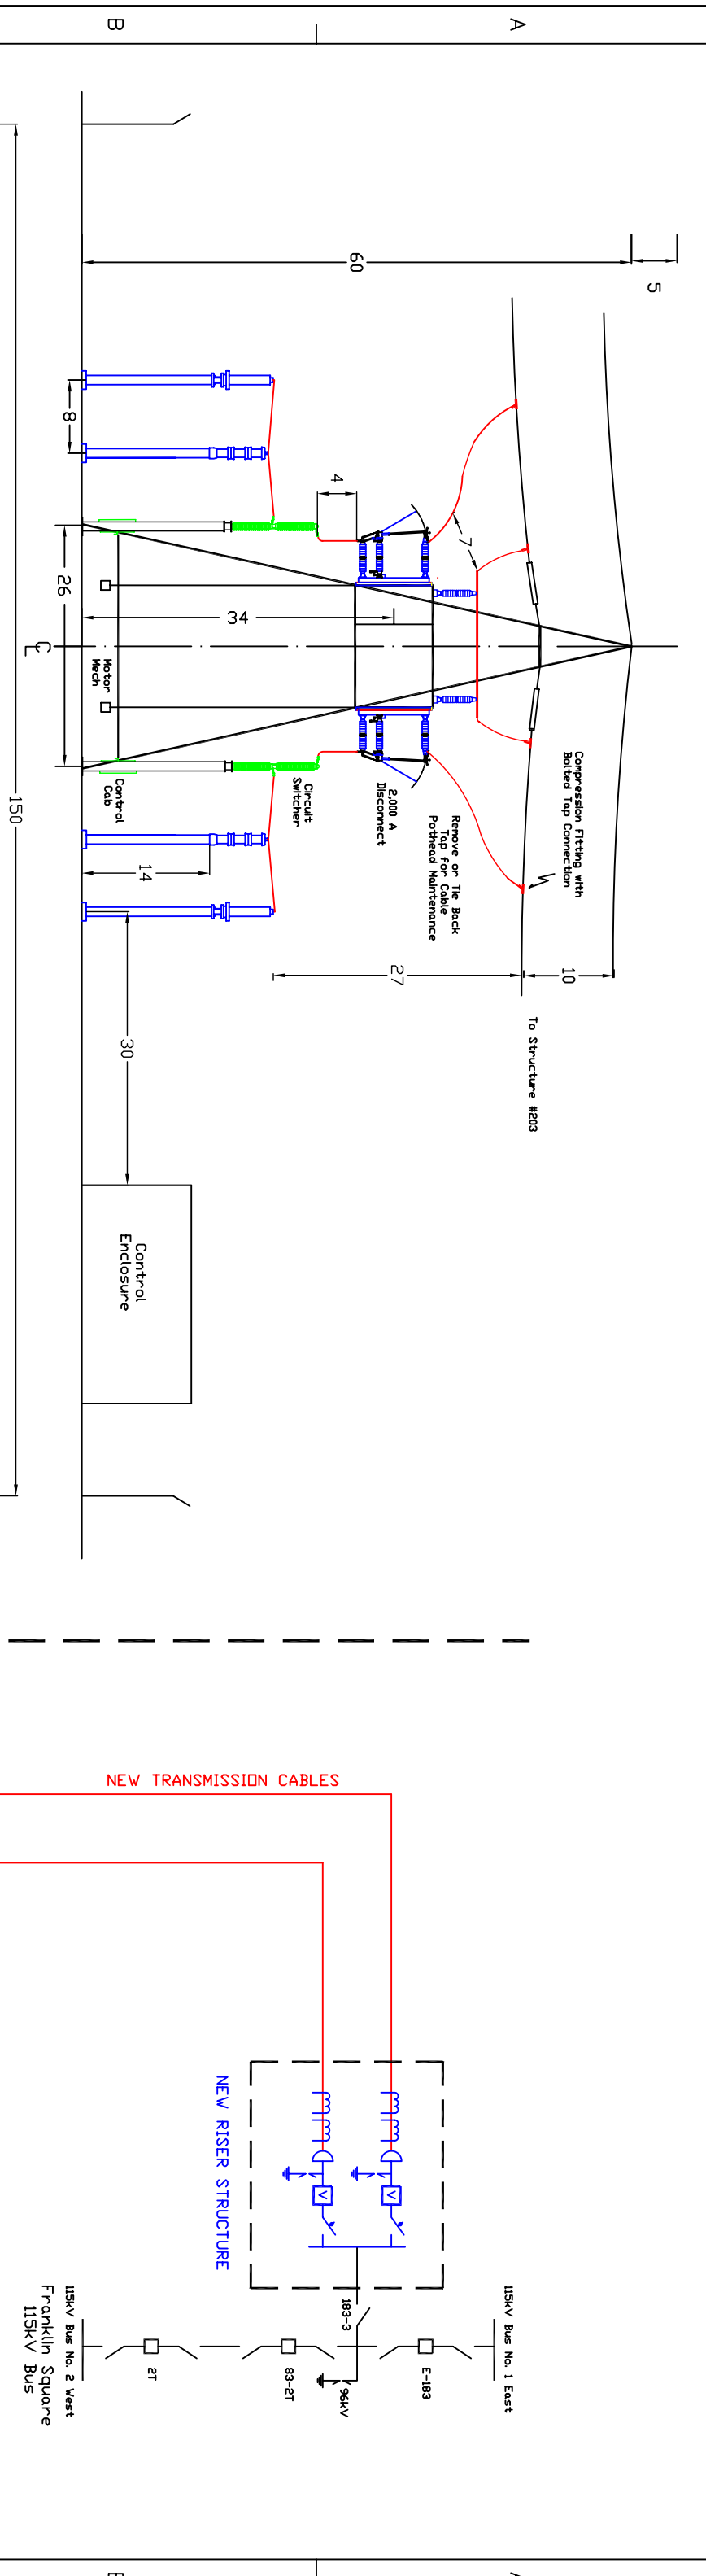

All Dimensions in Feet

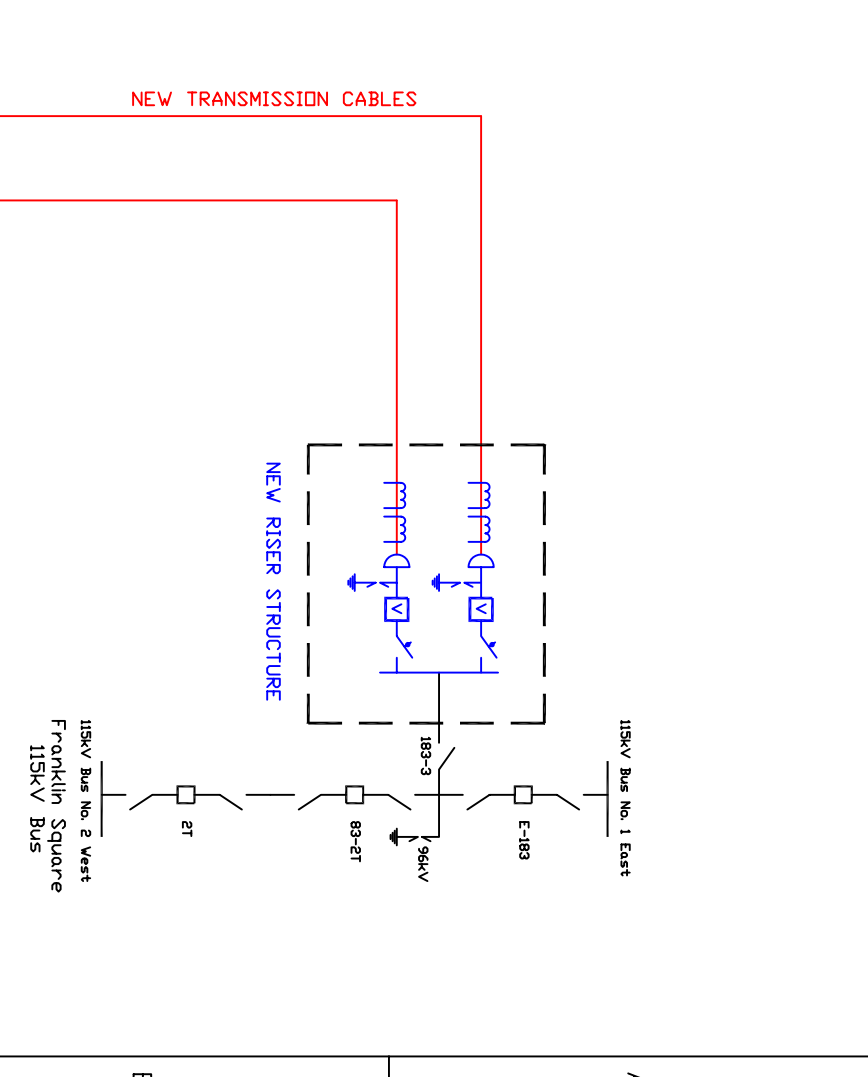

LINE RATINGS
 Summer 2,000A
 Winter 2,400A

SHORT CIRCUIT DUTY
 3-Phase 39,814A
 SI-g 16,737A

REV.	DATE	DESCRIPTION	BY	CHK	DWG	APP	REV.	DATE	DESCRIPTION	BY	CHK	DWG	APP
7							3	8/18	INCREASED CLEARANCE	RAJ			
6							2	3/4	MODIFIED CONTROL ENCL. ENCLOSURE	RAJ			
5							1	8/28	MODIFIED STATION LAYOUT & DIMS	RAJ			
4	4/4	ADD THRU CONN. MODIFIED CONTROL ENCL. RAJ	RAJ				0	9/24	DELETIONAL ISSUE	RAJ			

Sheet 1 of 2

The Narragansett Electric Company
 Providence, Rhode Island

E-183 115kV Transmission Line
 Providence & East Providence RI


Underground Alternative
 Tockwotten Transition Station

EF5B Dkt SB-2003-01
 ATTACHMENT NDL

SCALE: DMC - 2 4

REV.	DATE	DESCRIPTION
1		
2		
3		
4		
5		
6		
7		
8		

DATE	DESCRIPTION	BY	CHECKED

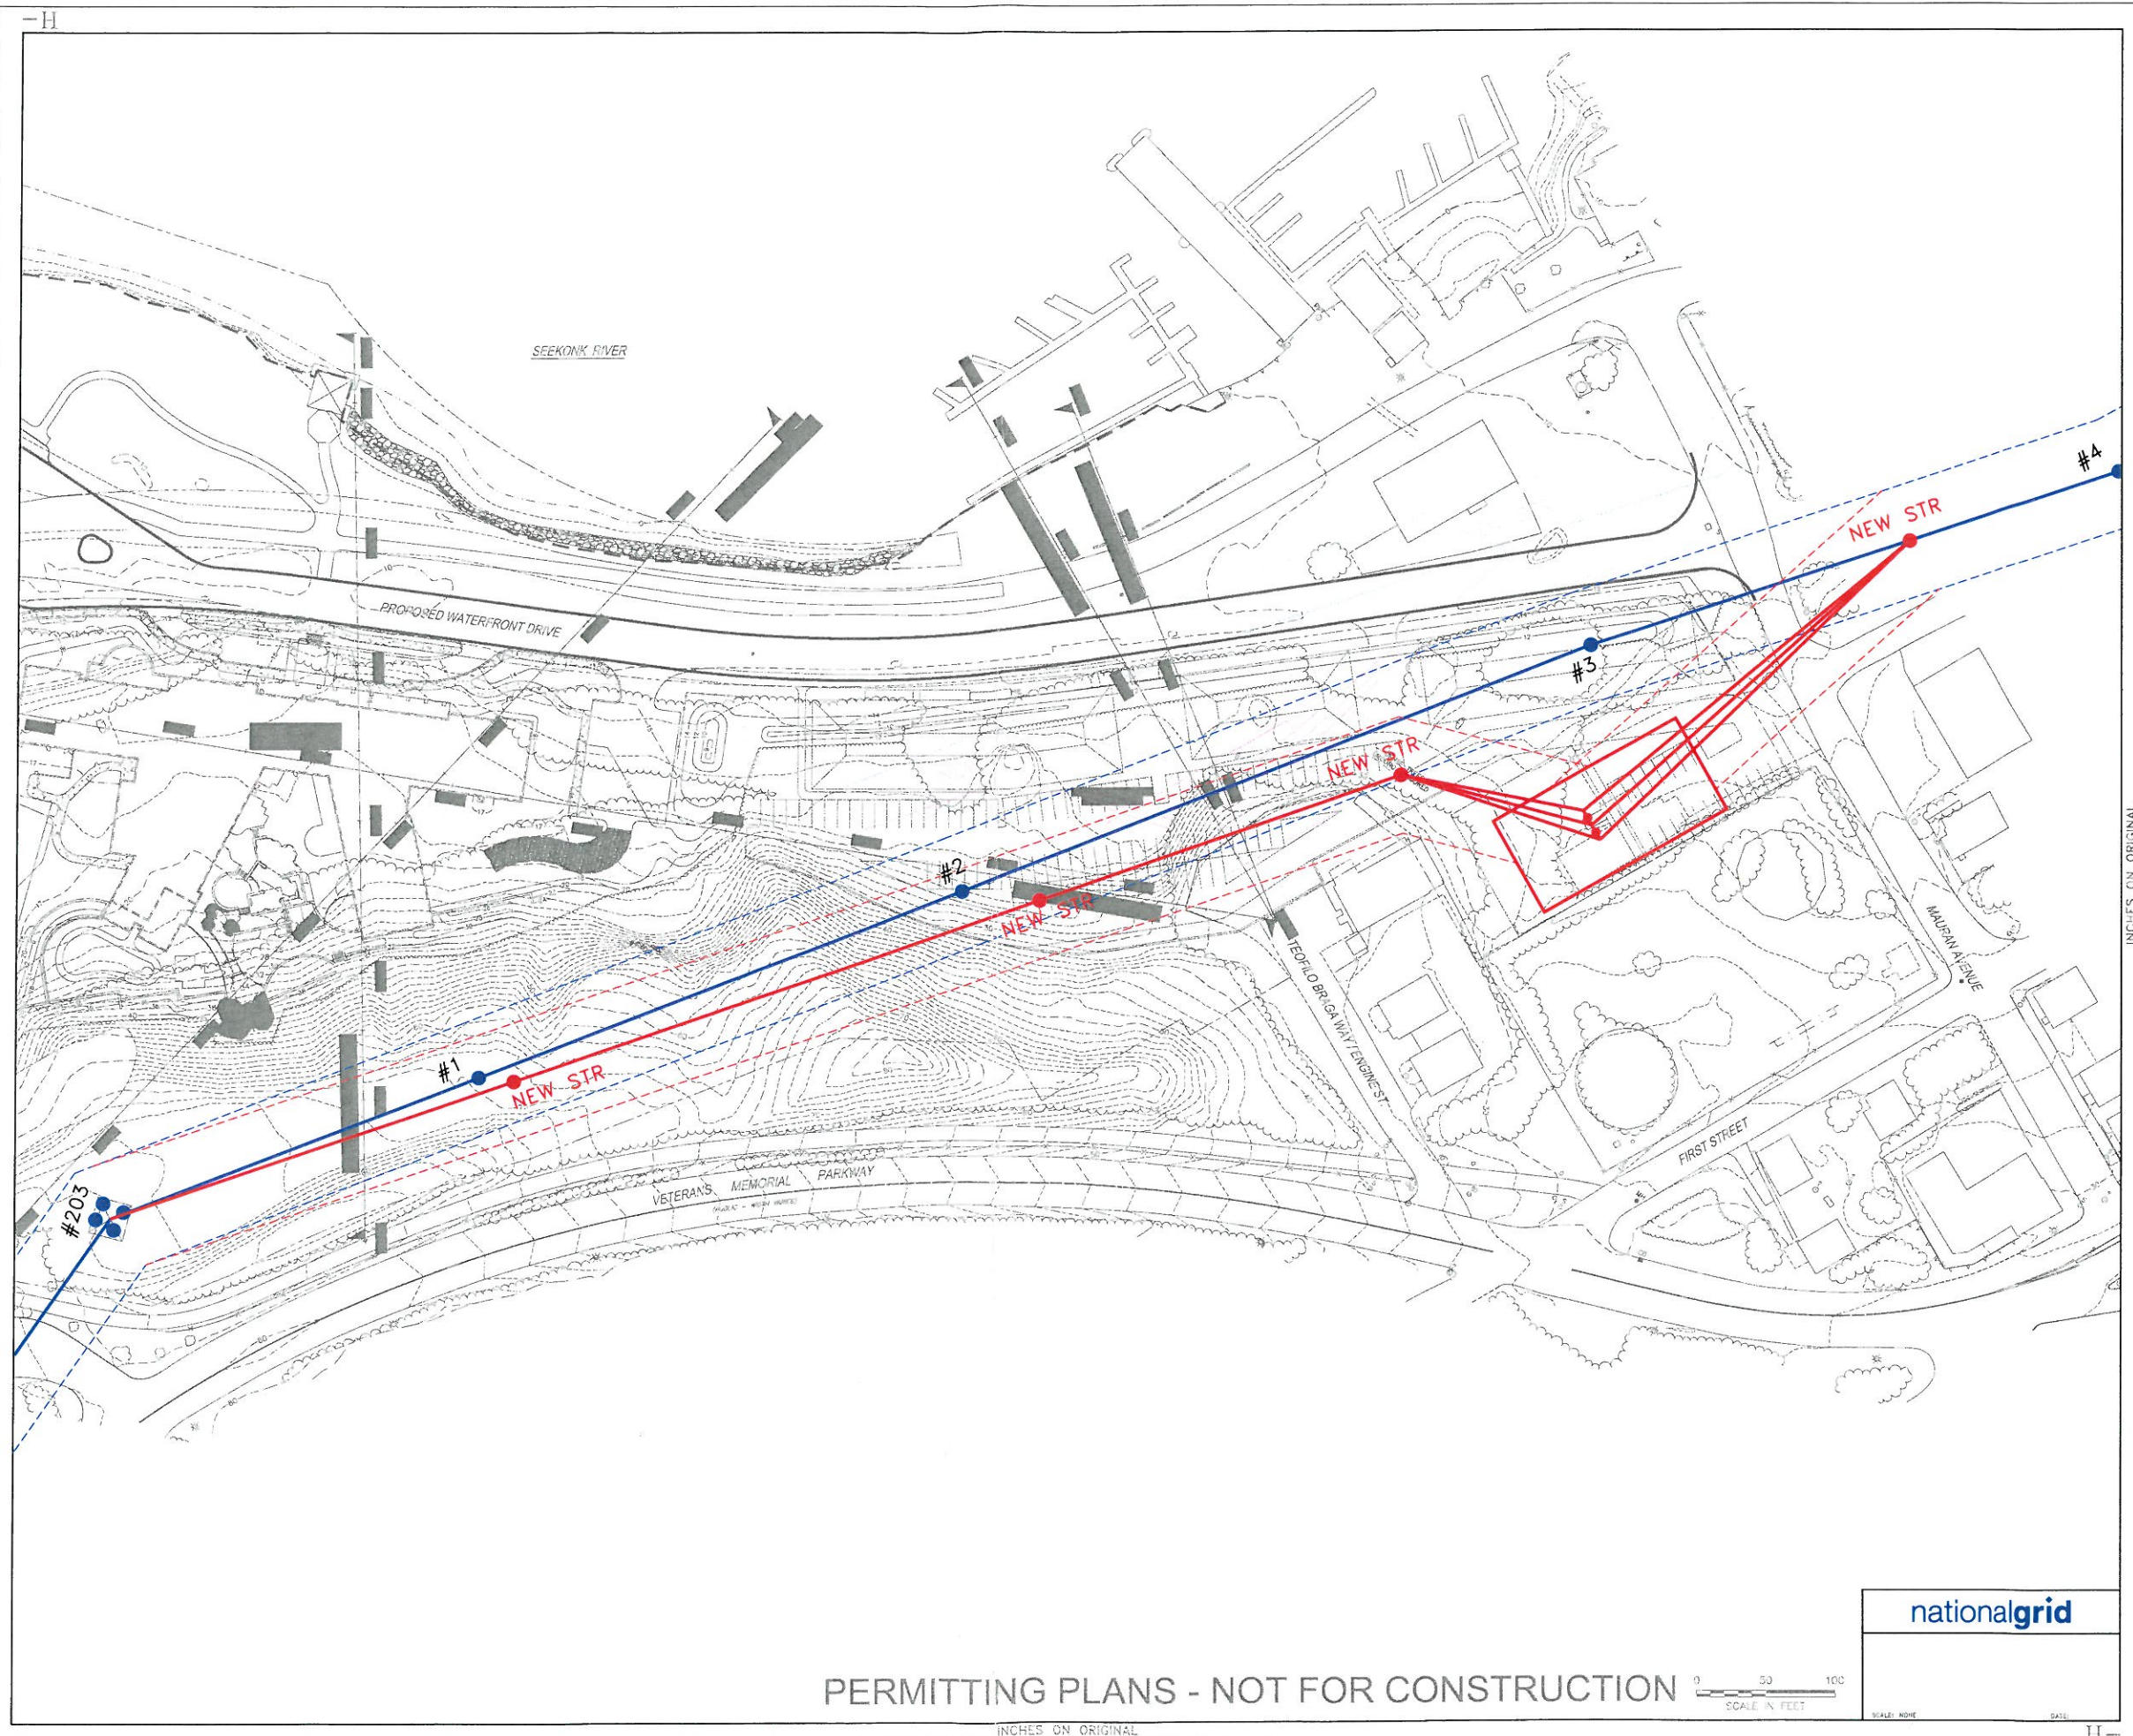

INCHES ON ORIGINAL

PERMITTING PLANS - NOT FOR CONSTRUCTION



nationalgrid

SCALE NONE DATE

INCHES ON ORIGINAL

H-